

DEVELOPMENT APPLICATION

APPLICATION NUMBER: PLN-23-355

PROPOSED DEVELOPMENT: Single dwelling and Outbuilding (Residential)

LOCATION: 47 Wallcrest Road Berriedale

APPLICANT: Tassie Homes Pty Ltd

ADVERTISING START DATE: 28/08/2024

ADVERTISING EXPIRY DATE: 10/09/2024

Plans and documentation are available for inspection at Council's Offices, located at 374 Main Road, Glenorchy between 8.30 am and 5.00 pm, Monday to Friday (excluding public holidays) and the plans are available on Glenorchy City Council's website (www.gcc.tas.gov.au) until 10/09/2024.

During this time, any person may make representations relating to the applications by letter addressed to the General Manager, Glenorchy City Council, PO Box 103, Glenorchy 7010 or by email to gccmail@gcc.tas.gov.au.

Representations must be received by no later than 11.59 pm on **10/09/2024**, or for postal and hand delivered representations, by 5.00 pm on **10/09/2024**.

ABN 19 753 252 493

H1309 - Proposed Dwelling, SORMAN & JOHNS AT 47 WALLCREST ROAD, BERRIEDALE

Architectural Drawing No.	Description
01	Location Plan
01a	Site Plan
02	Drainage Plan
02a	Shed Floor Plan
02b	Shed Elevations
03	Floor Plan
04	Elevations
05	Section
06	Roof Plan
07	Electrical Plan
08	Flooring Layout Plan
09	Lighting Calculations, Insulation & Window Schedule
10	Compliance Notes
11	Wet Area Specifications
11a	Stair Notes
11b	Balustrade Notes
12	Vegetation Overlay
13	BAL Construction Requirements

GLENORCHY CITY COUNCIL PLANNING SERVICES

APPLICATION No.: PLN-23-355

DATE RECEIVED: 20/07/2024



Climate Zone - 7

C.T. No. 182104/100

Wind Speed - N3

Corrosion Environment -MODERATE

Soil Classification - S

Floor Area = 279.6m²

= 30.1 sq

PROTECTIVE COATINGS FOR STEELWORK

END ADONOMENT	LOCATION	MINIMUM PROTECTIVE COATING		
ENVIRONMENT		General stru	ictural steel members	Lintels in masonry
MODERATE	INTERNAL		No protection requir	red
More than 1km from breaking surf or more than 100m from salt water not subject to breaking surf or non- heavy industrial areas	EXTERNAL	Option 1 Option 2 Option 3 Option 4	2 coats alkyd prime 2 coats alkyd gloss Hot dip galvanise 3(Hot dip galvanise 1((a) 1 coat solvent b (b) 1 coat vinyl glo	00 g/m² min. 00 g/m² min. plus - pased vinyl primer; or

- 1. Heavy industrial areas means industrial environments around major industrial complexes. There are only a few such regions in Australia examples of which occur around Port Pirie and Newcastle
- 2. The outer leaf and cavity of an external masonry wall of a building, including walls under open carports are considered to be external environments. A part of an internal leaf of an external masonry wall which is located in the roof space is considered to be in an internal
- 3. Where a paint finish is applied the surface of the steel work must be hand or power tool cleaned to remove any rust immediately
- 4. All zinc coatings (including inorganic zinc) require a barrier coat to stop conventional domestic enamels from peeling. 5. Refer to the paint manufacturer where decorative finishes are required on top of the minimum coating specified in the table for protection of the steel against corrosion.
- Internal locations subject to moisture, such as in close proximity to kitchen or bathroom exhaust fans are not considered to be in a
 permanently dry location and protection as specified for external locations is required.
- 7. For applications outside the scope of this table, seek specialist advice.

REVISION	DATE	SHEETS	DESCRIPTION
А	12 December 2023	00, 01, 01a, 02 & 02a, 02b, 03 - 09	Changes to architectural plans including Change cut to show bench between shed and house. Change driveway and re-work fireflighting requirements as necessary. Change garage plans as requested and show bathroom in garage. Update garage elevations to reflect changes. Show 2 x 23000 filtre water tanks and notes relating to TasWater supply and connections. Re-do drainage plan to reflect cut and drainage changes. Show sky light in pantry, change shelwings its ridge stees, silding door direction off rumpus. Change laundry layout, Make numerous electrical plan changes. Update all changed floor plans and elevations. Re-do lighting calculations to reflect changes.
В	19 December 2023	00, 03, 04 & 07 - 09	Change s li ding door style, update all floor plans and elevations.
С	5 April 2024	00, 01a, 02b & 04	Provide exterior colours and finishes. Include Light Reflectance Values for all exterior surfaces.
D	21 June 2024	00, 01, 01a, new 01b, 02, 02b, 04, 05, 10, new 11b & 12	Provide multiple HMA plans, location and site plan changes including changing residence and shed locations. Update drainage plan, shed elevations, residence elevations and residence section. Amend cut levels and finished floor levels. Provide balustrade notes in case FSL to FGL exceeds 1000mm Amend notes where affected.
Е	28 June 2024	All architectural sheets	Change BAL rating to BAL-29. Make panelift door 5600 wide and change living window to sliding door. Update all sheets to reflect changes.

THIS PLAN IS ACCEPTED BY:
PLEASE NOTE: no variations will be permitted after plans are signed by the client (with exception of Council requirements / approvals). SIGNATURE:
DATE:

BAL-29

See sheet 13 for **Bushfire Attack Level** construction requirements

© This document is copyright and may not be reproduced without the written consent of Tassie Homes. Drafted by Phil Chamberlain, Accreditation CC5652Y

DRAWING: FILE NAME: DRAWN BY: COVER SHEET 28/06/24 H1309 DA 210923.dgn

COVER SHEET

7 NOVEMBER 2023

Development application drawings (DA)

Preliminary construction drawings Engineer not to sign this copy, only provide notes, additions & amendments

Final construction drawings (BA)


Approved by Building Surveyor


Approved by Engineer

Document Set ID: 3898099

Version: 1, Version Date: 29/08/2024


28 JUNE 2024

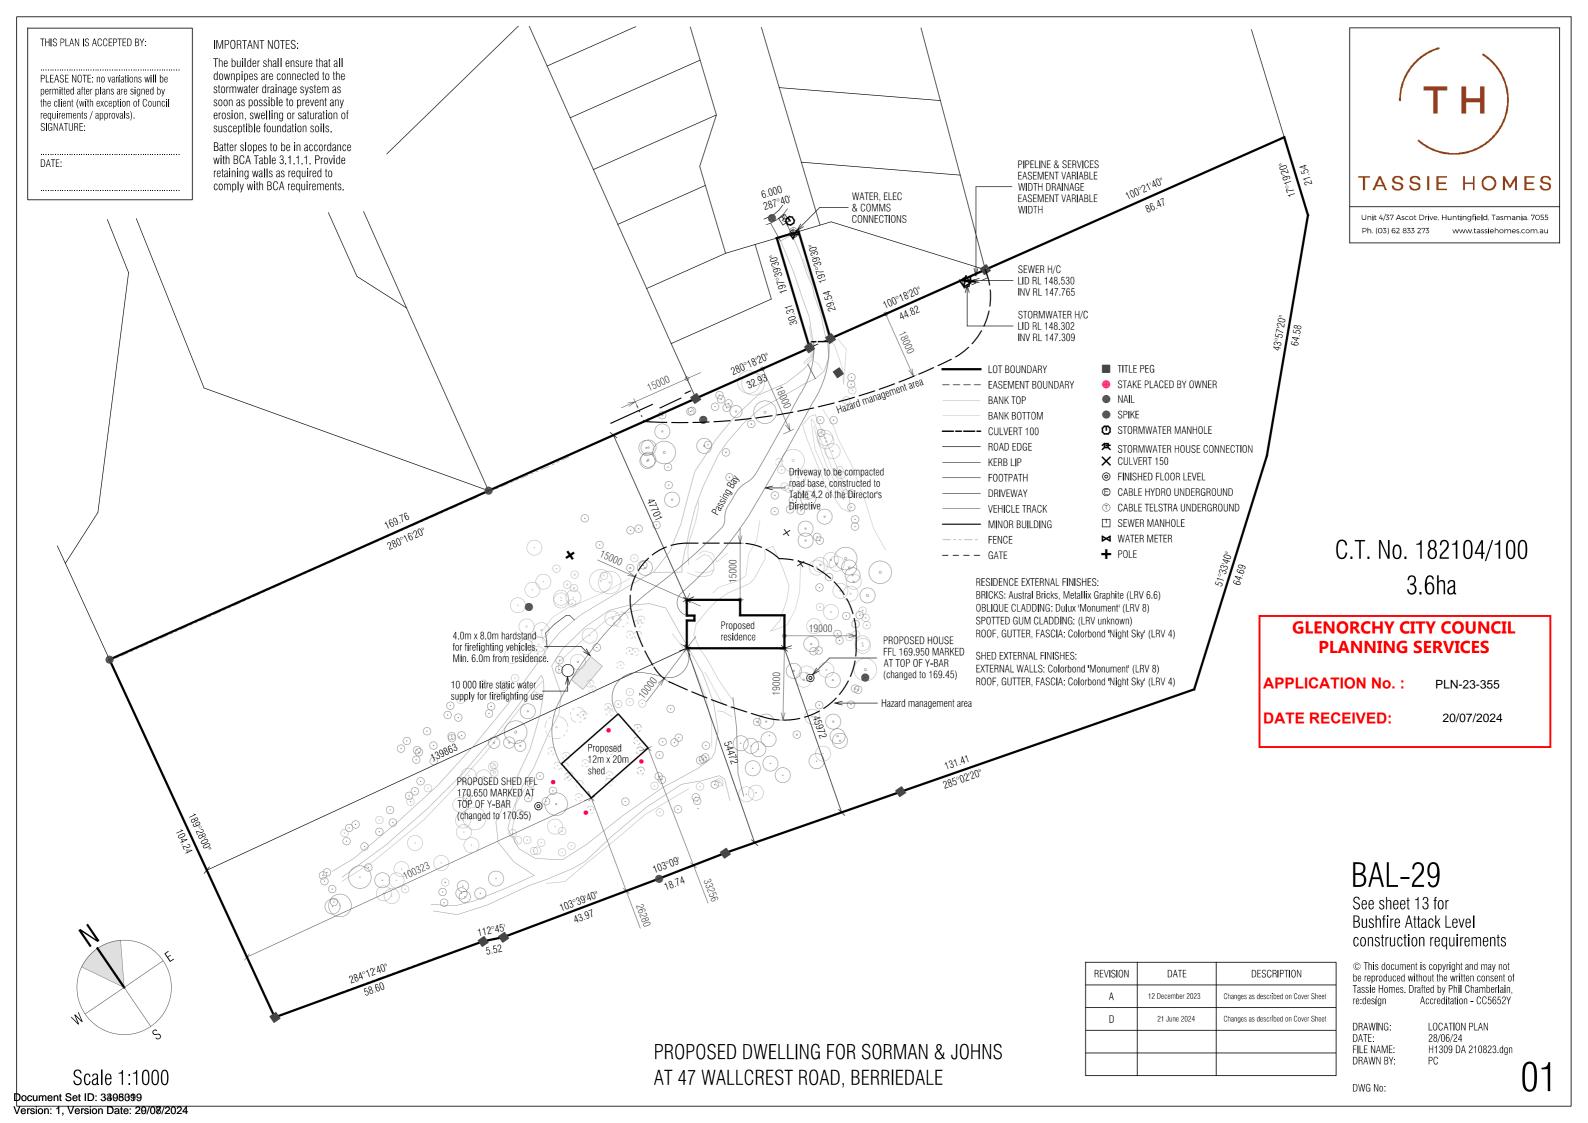


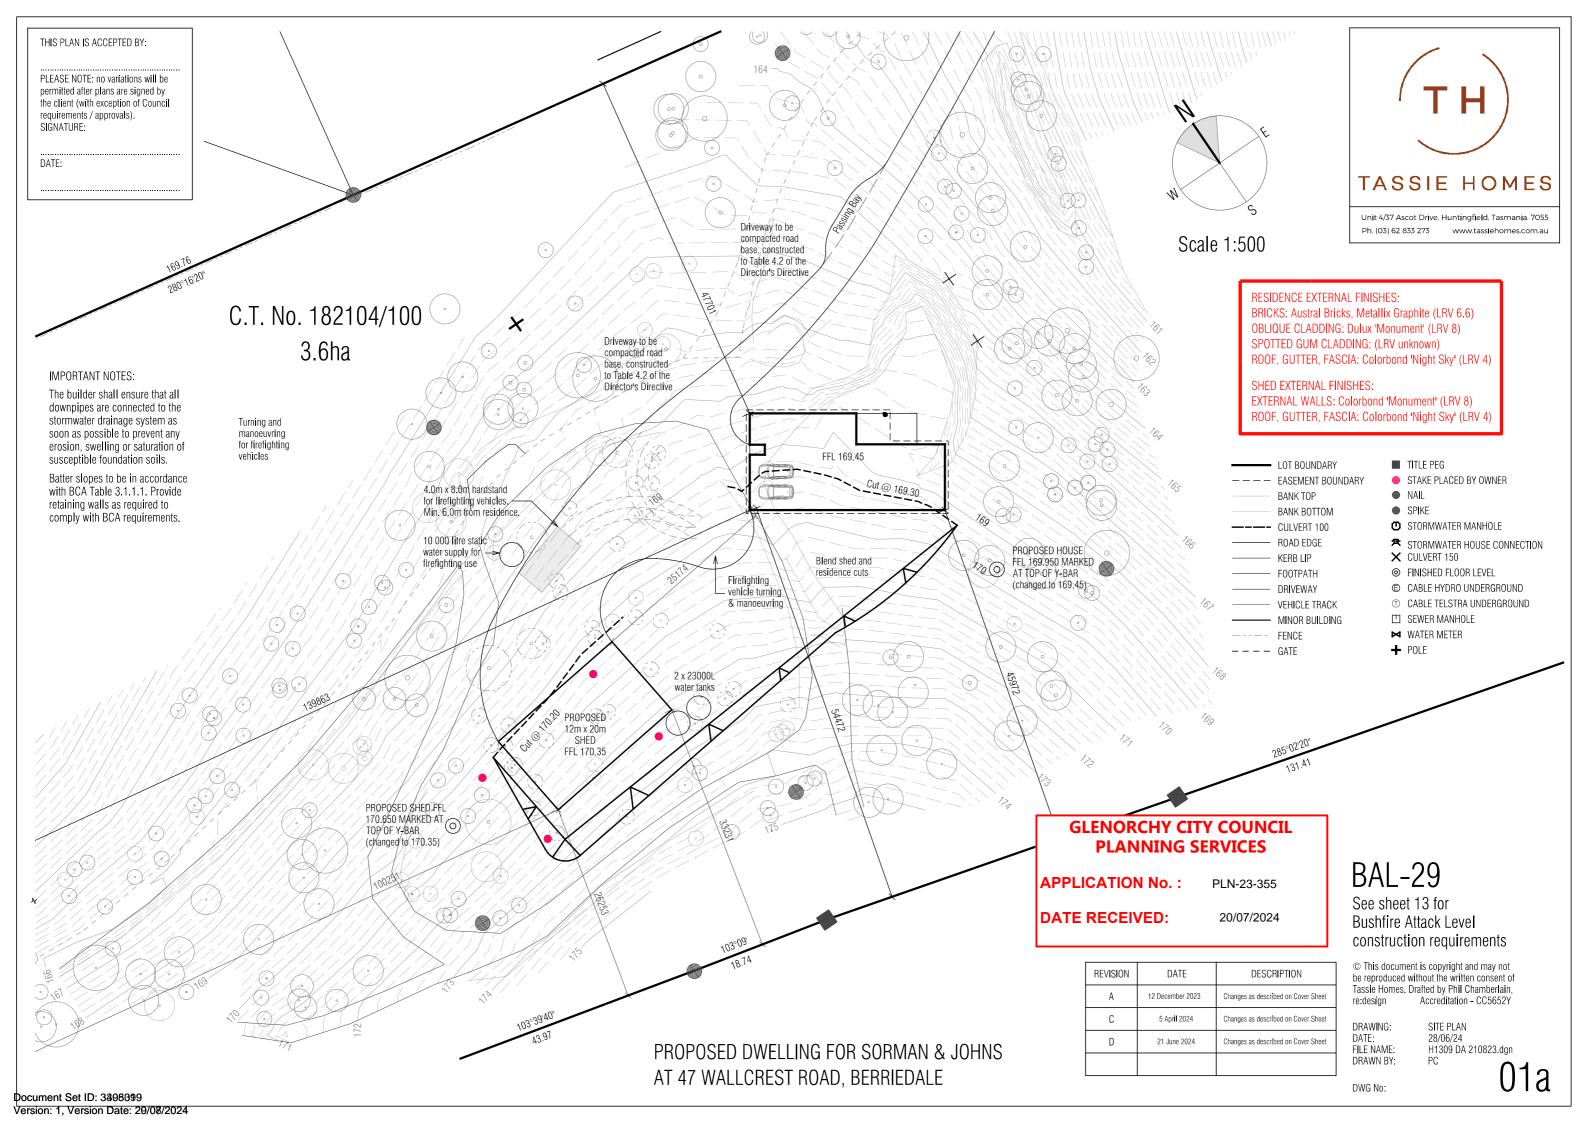

PLEASE NOTE: no variations will be permitted after plans are signed by the client (with exception of Council requirements / approvals). SIGNATURE:

DATE:

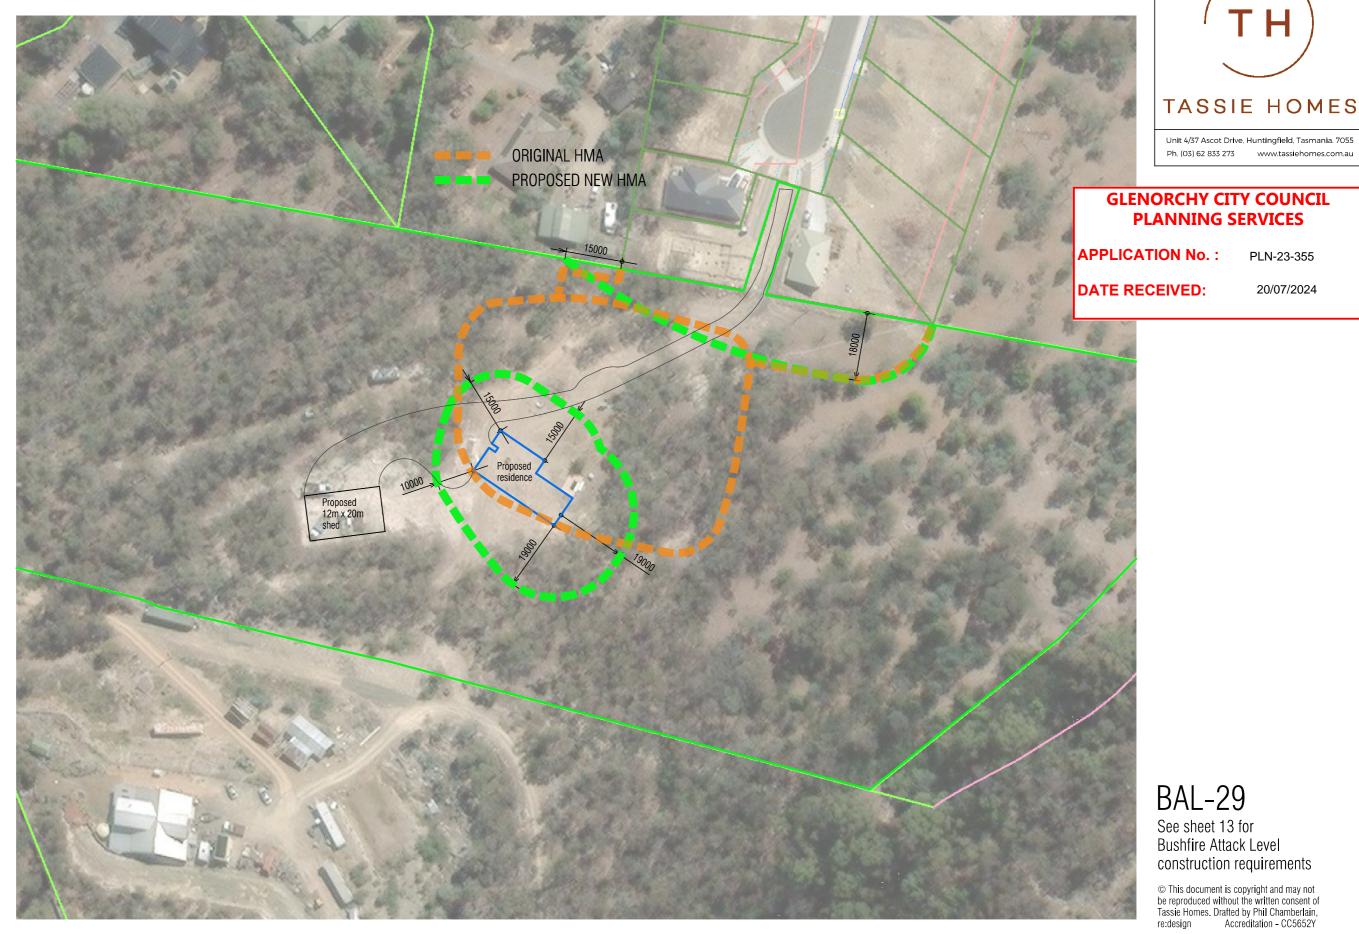

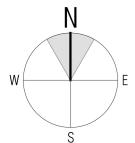

Scale 1:1000

PROPOSED DWELLING FOR SORMAN & JOHNS AT 47 WALLCREST ROAD, BERRIEDALE

REVISION	DATE	DESCRIPTION
D	21 June 2024	Changes as described on Cover Sheet



See sheet 13 for Bushfire Attack Level construction requirements

© This document is copyright and may not be reproduced without the written consent of Tassie Homes. Drafted by Phil Chamberlain, re:design Accreditation - CC5652Y re:design

DRAWING: DATE: FILE NAME: DRAWN BY

REVISED HAZARD MANAGEMENT AREA 28/06/24 H1309 DA 210823.dgn PC

Unit 4/37 Ascot Drive, Huntingfield, Tasmania. 7055


Ph. (03) 62 833 273 www.tassiehomes.com.au

PLN-23-355

20/07/2024

DWG No:

01b

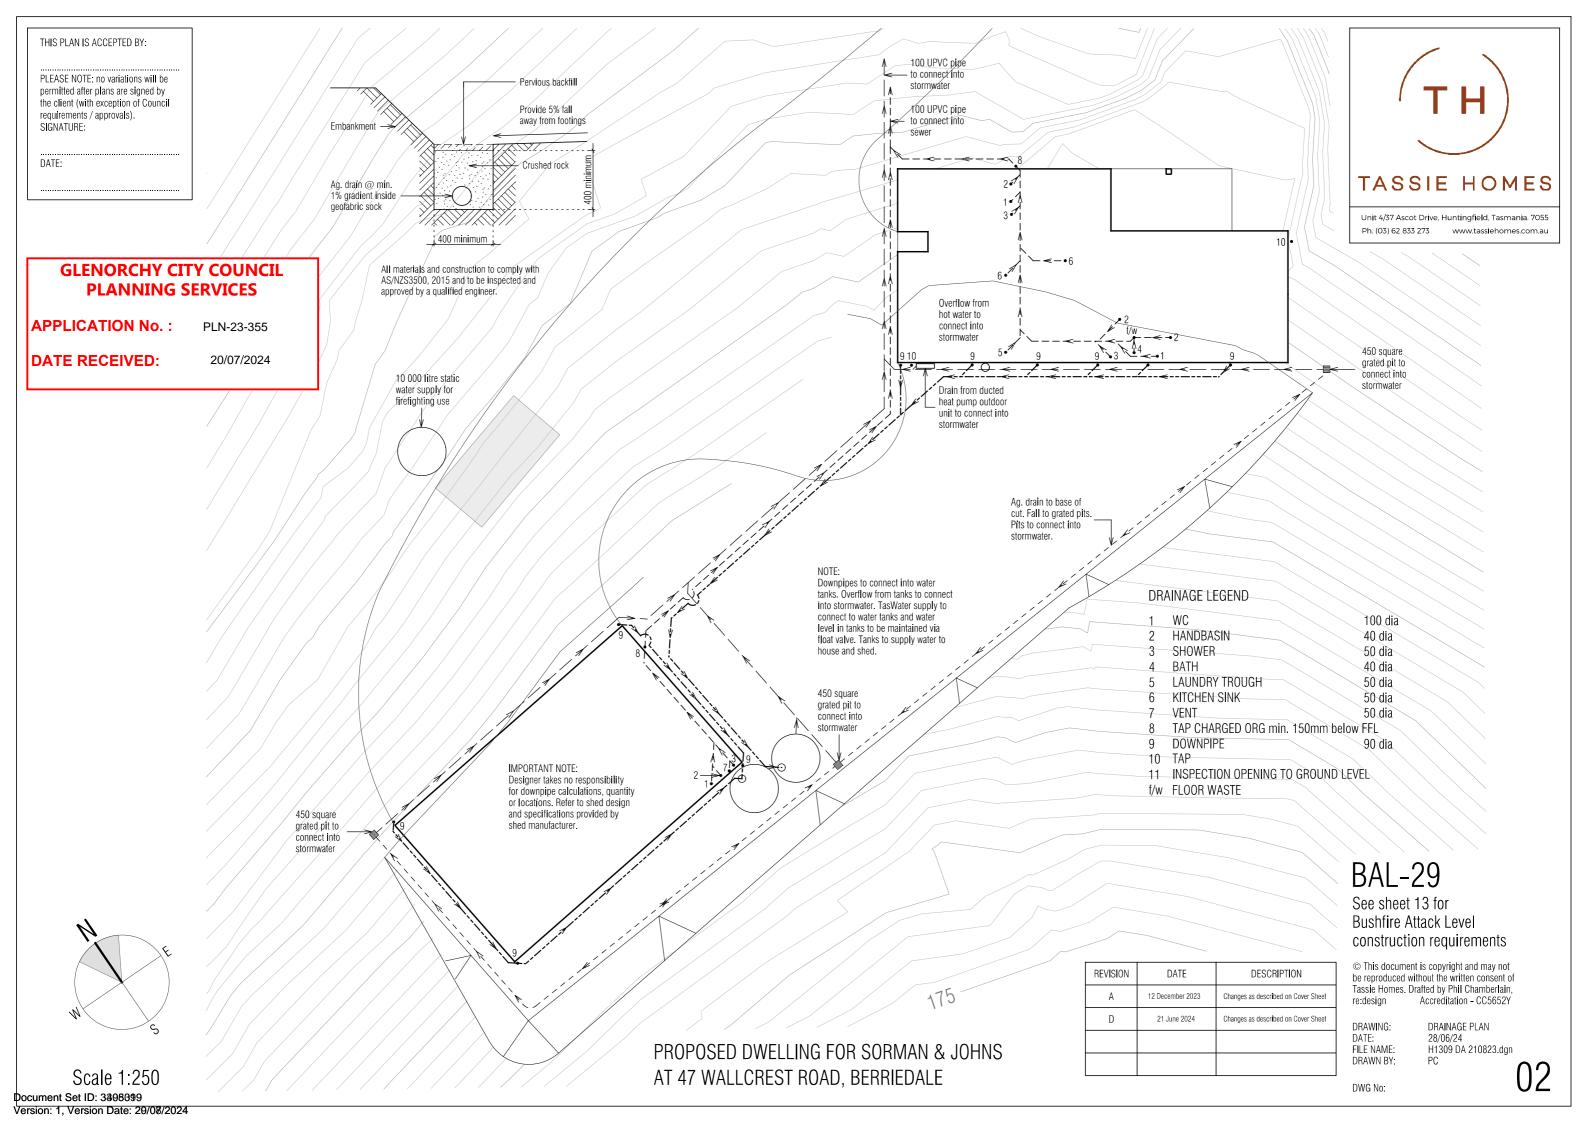

THIS PLAN IS ACCEPTED BY:	
PLEASE NOTE: no variations will be permitted after plans are signed by the client (with exception of Council requirements / approvals). SIGNATURE:	•
DATE	

Floor Area = 240.0m²

GLENORCHY CITY COUNCIL PLANNING SERVICES


APPLICATION No.: PLN-23-355

DATE RECEIVED: 20/07/2024



Unit 4/37 Ascot Drive, Huntingfield, Tasmania. 7055 Ph. (03) 62 833 273 www.tassiehomes.com.au

+	20000	+	
F	3370 wide roller door 3370 wide roller door 3370 wide roller door 4	21-21SD (dg)	\
		į	
	NOTE: Shed floor plan based on plans provided by STEELINE ROOFING		
_			12000
		3000	-
		2910	
	1700	750 \\ \(\)	
b		09-06AW (dg)	+

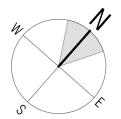

Scale 1:100

PROPOSED DWELLING FOR SORMAN & JOHNS AT 47 WALLCREST ROAD, BERRIEDALE

REVISION	DATE	DESCRIPTION
А	12 December 2023	Changes as described on Cover Sheet

BAL-29 See sheet 13 for Bushfire Attack Level

construction requirements
© This document is copyright and may not


© This document is copyright and may not be reproduced without the written consent of Tassie Homes. Drafted by Phil Chamberlain, re:design Accreditation - CC5652Y


DRAWING: DATE: FILE NAME: DRAWN BY: SHED FLOOR PLAN 28/06/24 H1309 DA 210823.dgn PC

: No:

02a

DWG No:

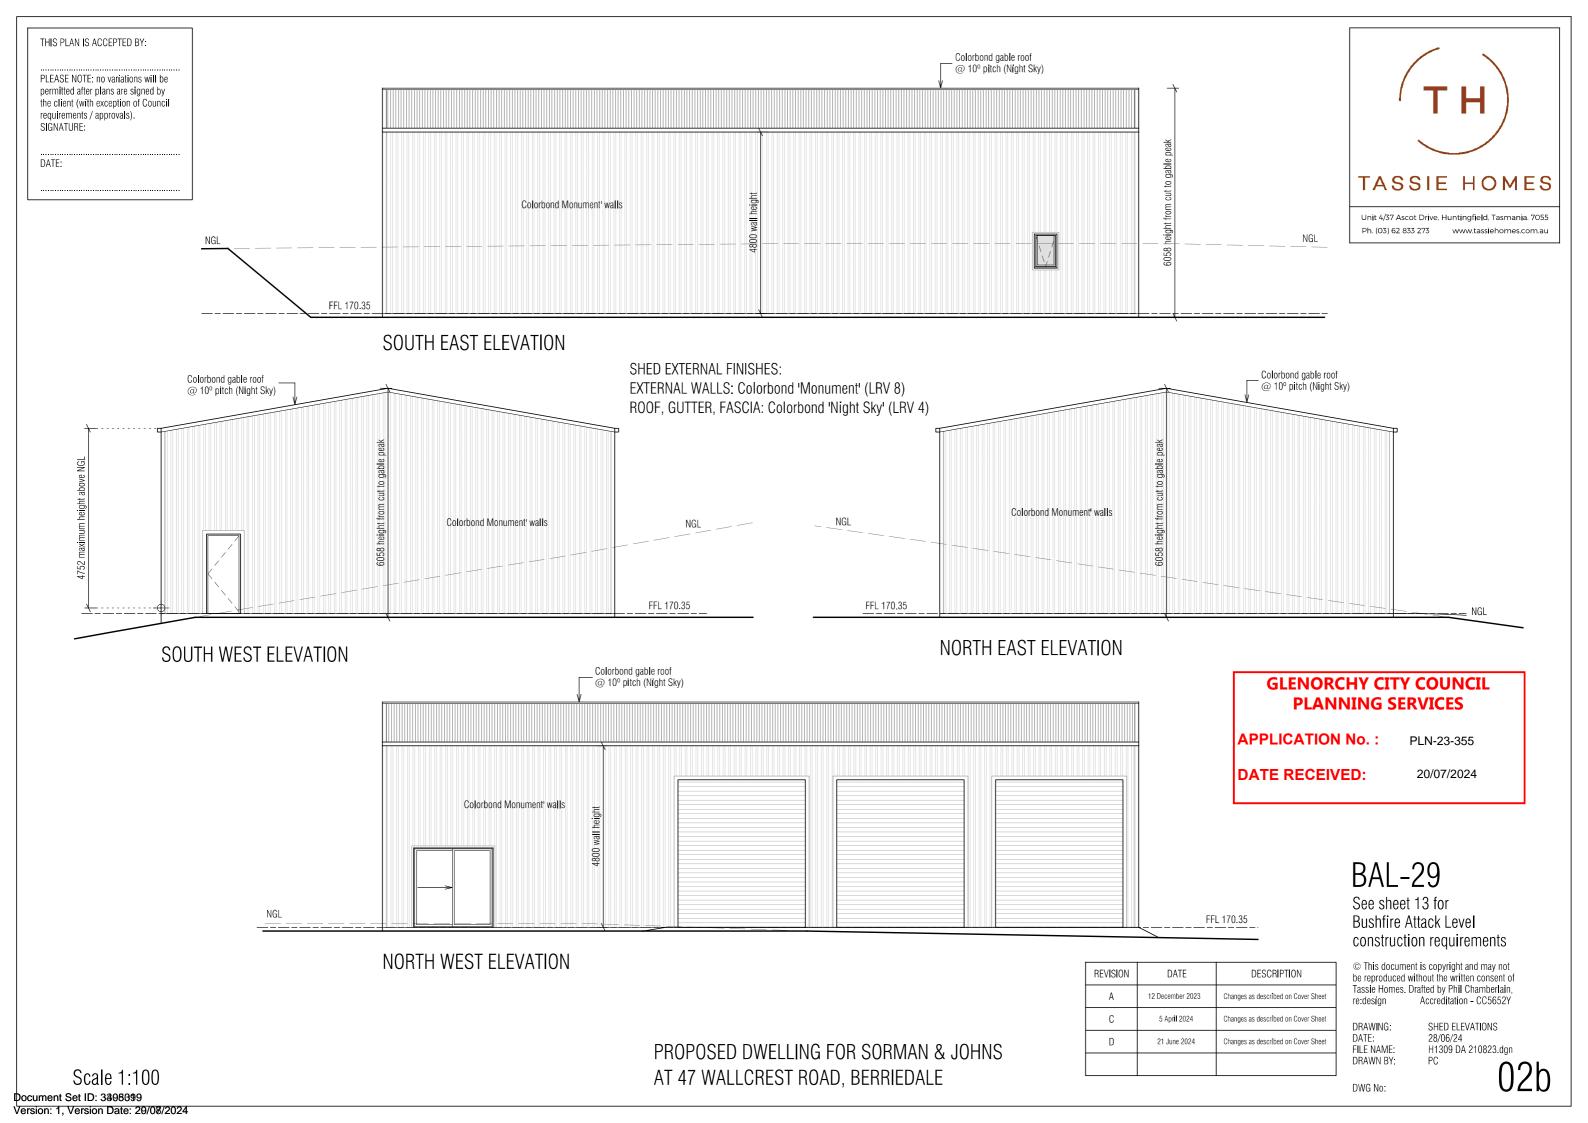


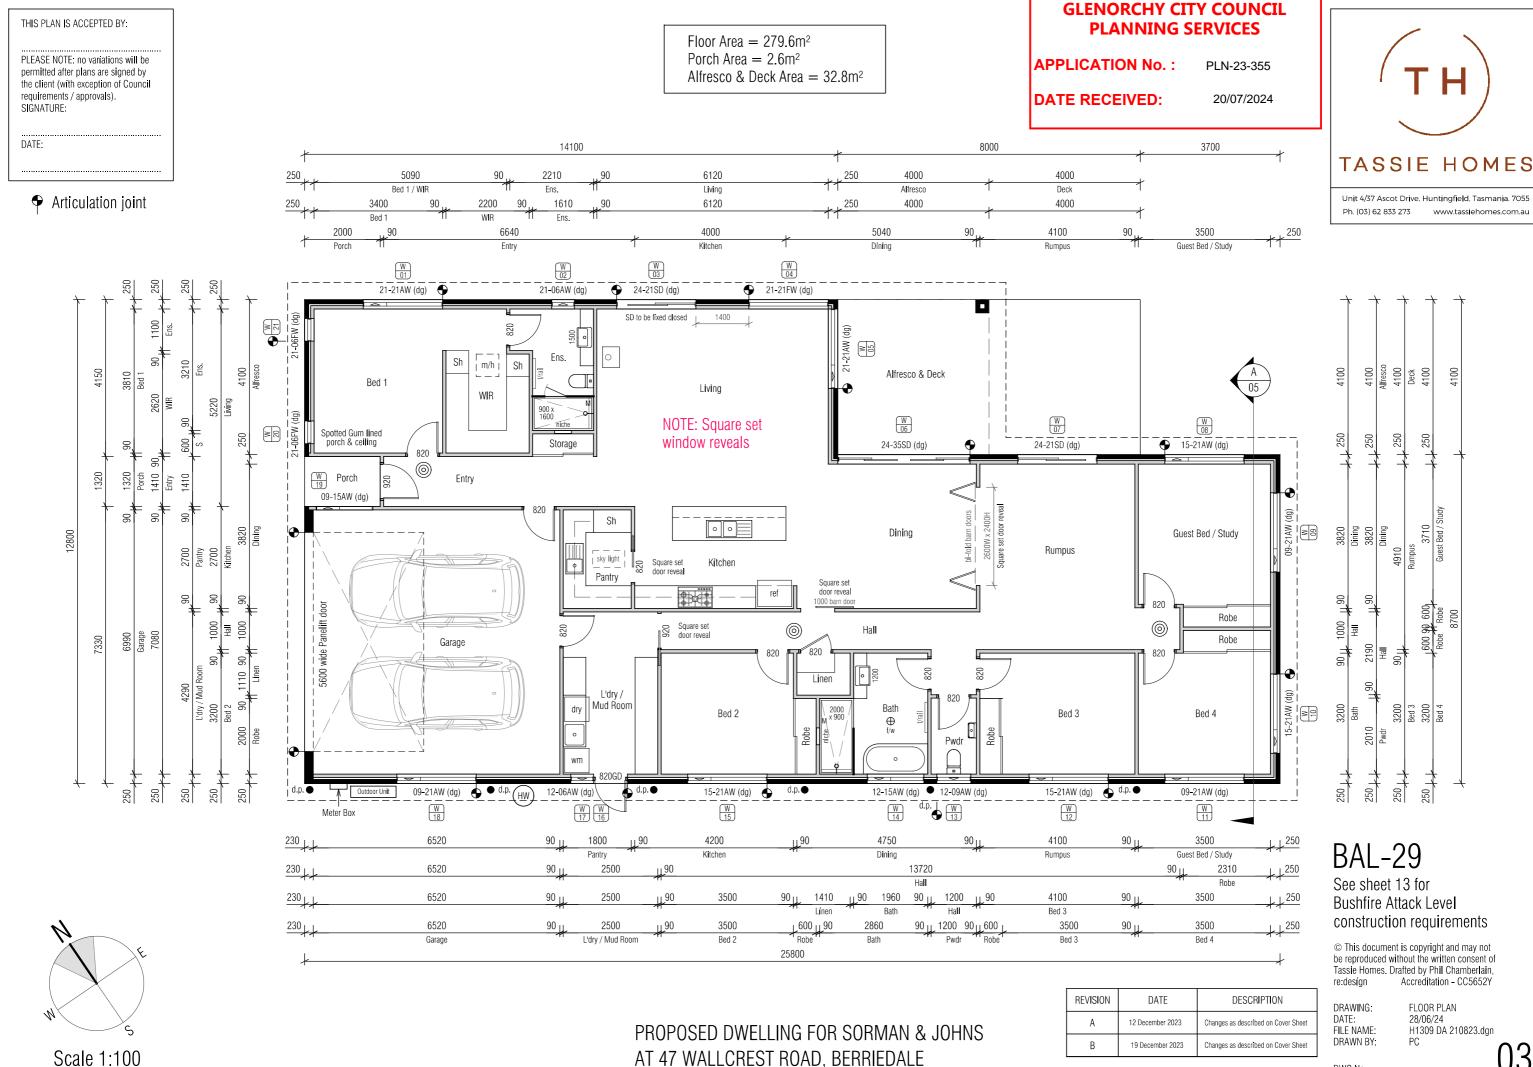

Document Set ID: 3398099 Version: 1, Version Date: 29/08/2024 AT 47 WALLCREST ROAD, BERRIEDALE

DWG No:

03

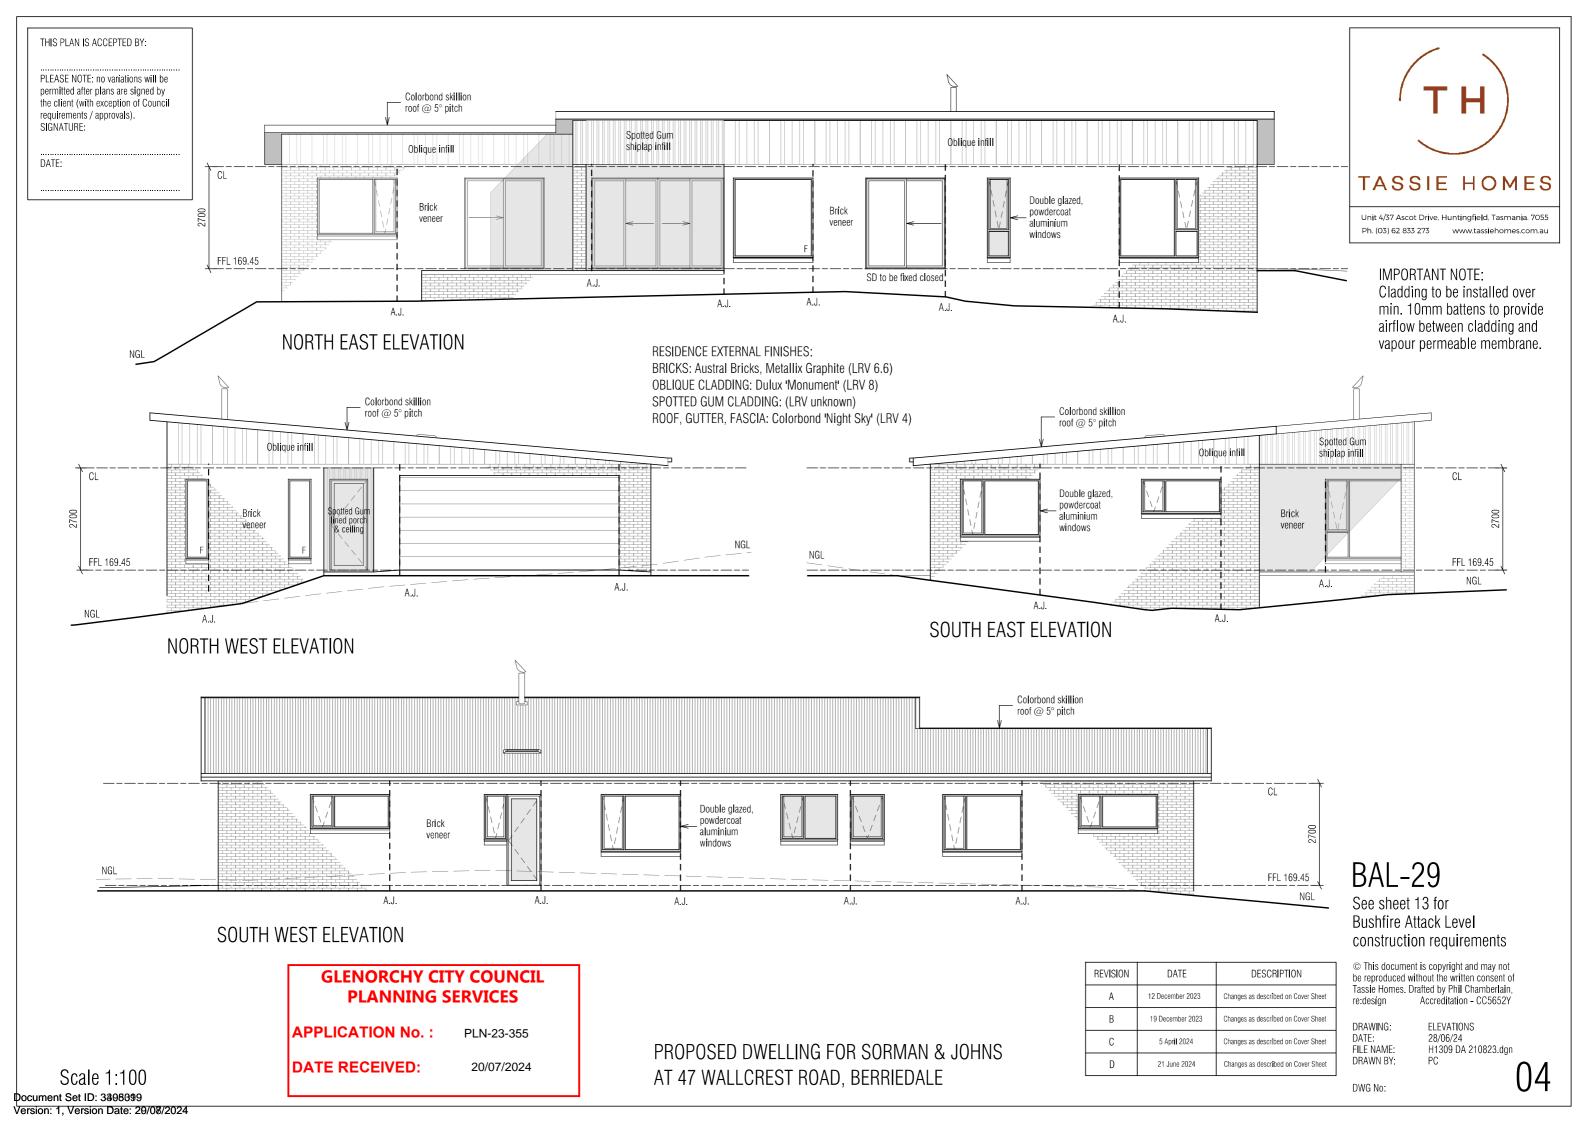

PLEASE NOTE: no variations will be permitted after plans are signed by the client (with exception of Council requirements / approvals). SIGNATURE:

DATE

IMPORTANT NOTE:

Cladding to be installed over min. 10mm battens to provide airflow between cladding and vapour permeable membrane.


GLENORCHY CITY COUNCIL PLANNING SERVICES

APPLICATION No.: PLN-23-355

DATE RECEIVED: 20/07/2024



Unit 4/37 Ascot Drive, Huntingfield, Tasmania. 7055 Ph. (03) 62 833 273 www.tassiehomes.com.au

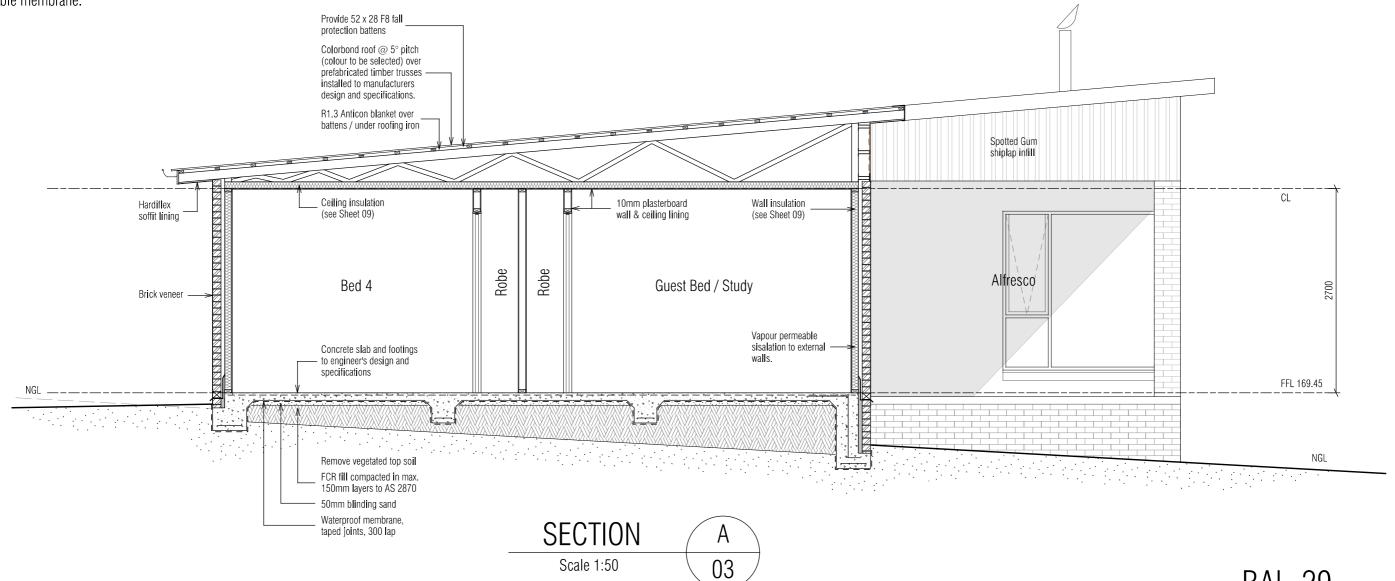

PROPOSED DWELLING FOR SORMAN & JOHNS AT 47 WALLCREST ROAD, BERRIEDALE

REVISION	DATE	DESCRIPTION
А	12 December 2023	Changes as described on Cover Sheet
D	21 June 2024	Changes as described on Cover Sheet

BAL-29 See sheet 13 for

Bushfire Attack Level construction requirements

© This document is copyright and may not be reproduced without the written consent of Tassie Homes. Drafted by Phil Chamberlain, re:design Accreditation - CC5652Y

DRAWING: DATE: FILE NAME: DRAWN BY

SECTION 28/06/24 H1309 DA 210823.dgn

05

DWG No:

PLEASE NOTE: no variations will be permitted after plans are signed by the client (with exception of Council requirements / approvals). SIGNATURE:

DATE

GLENORCHY CITY COUNCIL PLANNING SERVICES

20/07/2024

APPLICATION No.: PLN-23-355

DATE RECEIVED:

REVISION

DATE

12 December 2023

DESCRIPTION

Changes as described on Cover Sheet



Ph. (03) 62 833 273 www.tassiehomes.com.au

Scale 1:100

CATCHMENT AREA NOTES:

Colorbond skillion roof @ 5° pitch

CATCHMENT AREA $1 = 58.6 \text{m}^2$

CATCHMENT AREA $2 = 58.6 \text{m}^2$ CATCHMENT AREA $3 = 58.6 \text{m}^2$

CATCHMENT AREA $4 = 58.6 \text{m}^2$

CATCHMENT AREA $5 = 55.7 \text{m}^2$

CATCHMENT AREA $6 = 60.9 \text{m}^2$

denotes roof area

d.p. denotes downpipe

denotes direction of fall

r.h. 🖎 denotes rain head

denotes 200 x 400 ridge vent

denotes 200 x 400 eaves vent

IMPORTANT NOTES:

The position and quantity of downpipes are not to be altered without consulting with designer. Areas shown are surface / catchment areas NOT plan areas.

Where downpipes are futher than 1.2m away from valley, refer to NCC 3.5.2.5 (b) All roof areas shown are indicative only and not to be used for any other purpose.

BAL-29

See sheet 13 for Bushfire Attack Level construction requirements

© This document is copyright and may not be reproduced without the written consent of Tassie Homes. Drafted by Phil Chamberlain, re:design Accreditation - CC5652Y

DRAWING: DATE: FILE NAME: PC DRAWN BY

ROOF PLAN 28/06/24 H1309 DA 210823.dgn PC

06

DWG No:

Catchment Area 1	Catchment Area 2	Catchment Area 3	Catchment Area 4	Catchment Area 5	Catchment Area 6
5º fall		- 5º fall	- 5º fall		5° fall
d.p. < fall		—> d.p. ← fall	d.p.	d.p. < fall	fa >> d.p.

DOWNP	IPE & ROC	OF CATCHMENT AREA CALCULATIONS (as per NCC Part 3.5.2)
Ah	337.4	Area of roof (including 115mm Quad Gutter) (m²)
Ac	350.1	Ah x slope factor (determined from Table 3.2 from AS/NZS 3500.3) (m²)
Gutter type	А	Cross sectional area 6500mm² (determined from NCC Table 3,5,2,2)
DRI	85	Design Rainfall Intensity Hobart (determined from NCC Table 3.5.2.1)
Acdp	70	Catchment area per 90mm downpipe (determined from NCC Table 3.5.2.2)
Downpipes Required	6	Ac Acdp
Downpipes Provided	6	

PROPOSED DWELLING FO	R SORMAN & JOHNS
AT 47 WALLCREST ROAD,	BERRIEDALE

PLEASE NOTE: no variations will be permitted after plans are signed by the client (with exception of Council requirements / approvals). SIGNATURE:

DATE:			

GLENORCHY CITY COUNCIL PLANNING SERVICES

APPLICATION No.: PLN-23-355

DATE RECEIVED: 20/07/2024

REVISION

DATE

12 December 2023


19 December 2023


DESCRIPTION

Changes as described on Cover Sheet

Changes as described on Cover Sheet



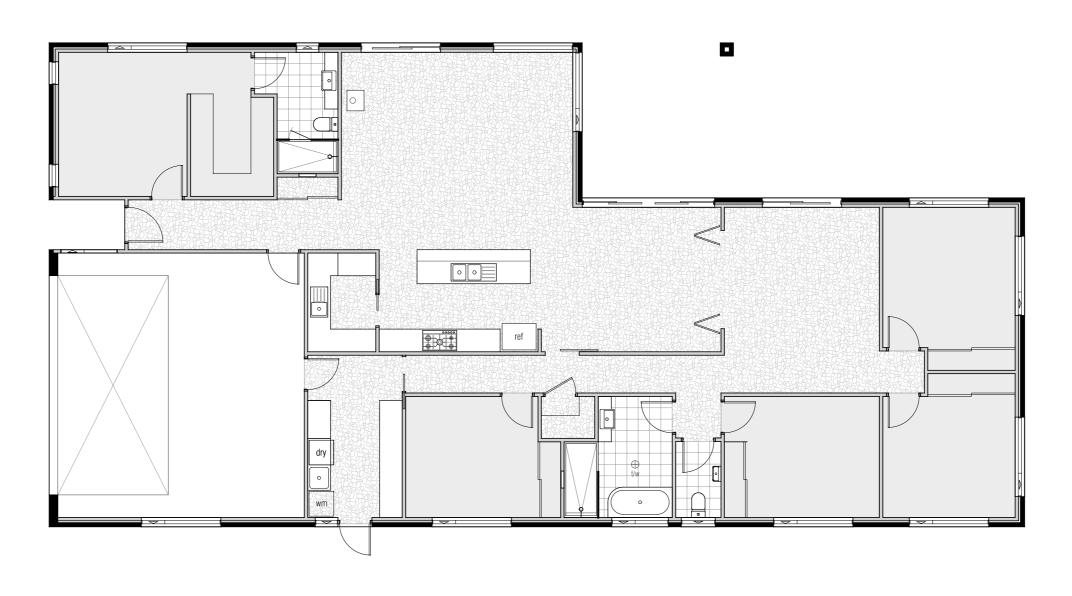

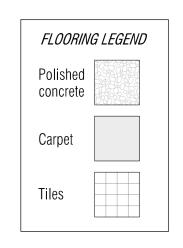

BAL-29

See sheet 13 for Bushfire Attack Level construction requirements

© This document is copyright and may not be reproduced without the written consent of Tassie Homes. Drafted by Phil Chamberlain, re:design Accreditation - CC5652Y

DRAWING: DATE: FILE NAME: DRAWN BY: FLOORING LAYOUT PLAN 28/06/24 H1309 DA 210823.dgn PC

80

DWG No:

PROPOSED DWELLING FOR SORMAN & JOHNS AT 47 WALLCREST ROAD, BERRIEDALE

CIVIL DRAWINGS **SORMAN & JOHNS**

D 20/08/2024 COVER A 15/07/2024 **ENGINEERING NOTES** D 20/08/2024 DRIVEWAY & STORMWATER PLAN - SHEET 1 DRIVEWAY & STORMWATER PLAN - SHEET 2 B 20/08/2024 LONG SECTIONS - SHEET 1 C 18/07/2024 DETAILS A 15/07/2024

47 WALLCREST ROAI
BERRIEDALE

			DRAWN:	DHJ
D	DEVELOPMENT APPLICATION	20/08/2024	CHECKED:	DE
С	DEVELOPMENT APPLICATION	18/07/2024	DESIGN:	DHJ
В	DEVELOPMENT APPLICATION	17/07/2024	CHECKED:	RP
Α	DEVELOPMENT APPLICATION	15/07/2024	VERIFIED:	DG
REV	ISSUE	DATE	APPROVAL	




Lower Ground
199 Macquarie Street
Hobart TAS 7000
03 6234 8666
mail@aldanmark.com.au
www.aldanmark.com.au


ROJECT:	SORMAN & JOHNS	ADDRESS:	47 WALLCREST ROAD BERRIEDALE	SHEET:	HEET: COVER					
		CLIENT:	TASSIE HOMES	SCALE:	AS INDICATED	TOTAL SHEETS: 6	SIZE: A1			
				PROJECT No	21 □ 12 11	SHEET: COO1	REV: D			

GLENORCHY CITY COUNCIL PLANNING SERVICES

APPLICATION No.: PLN-23-355

DATE RECEIVED:

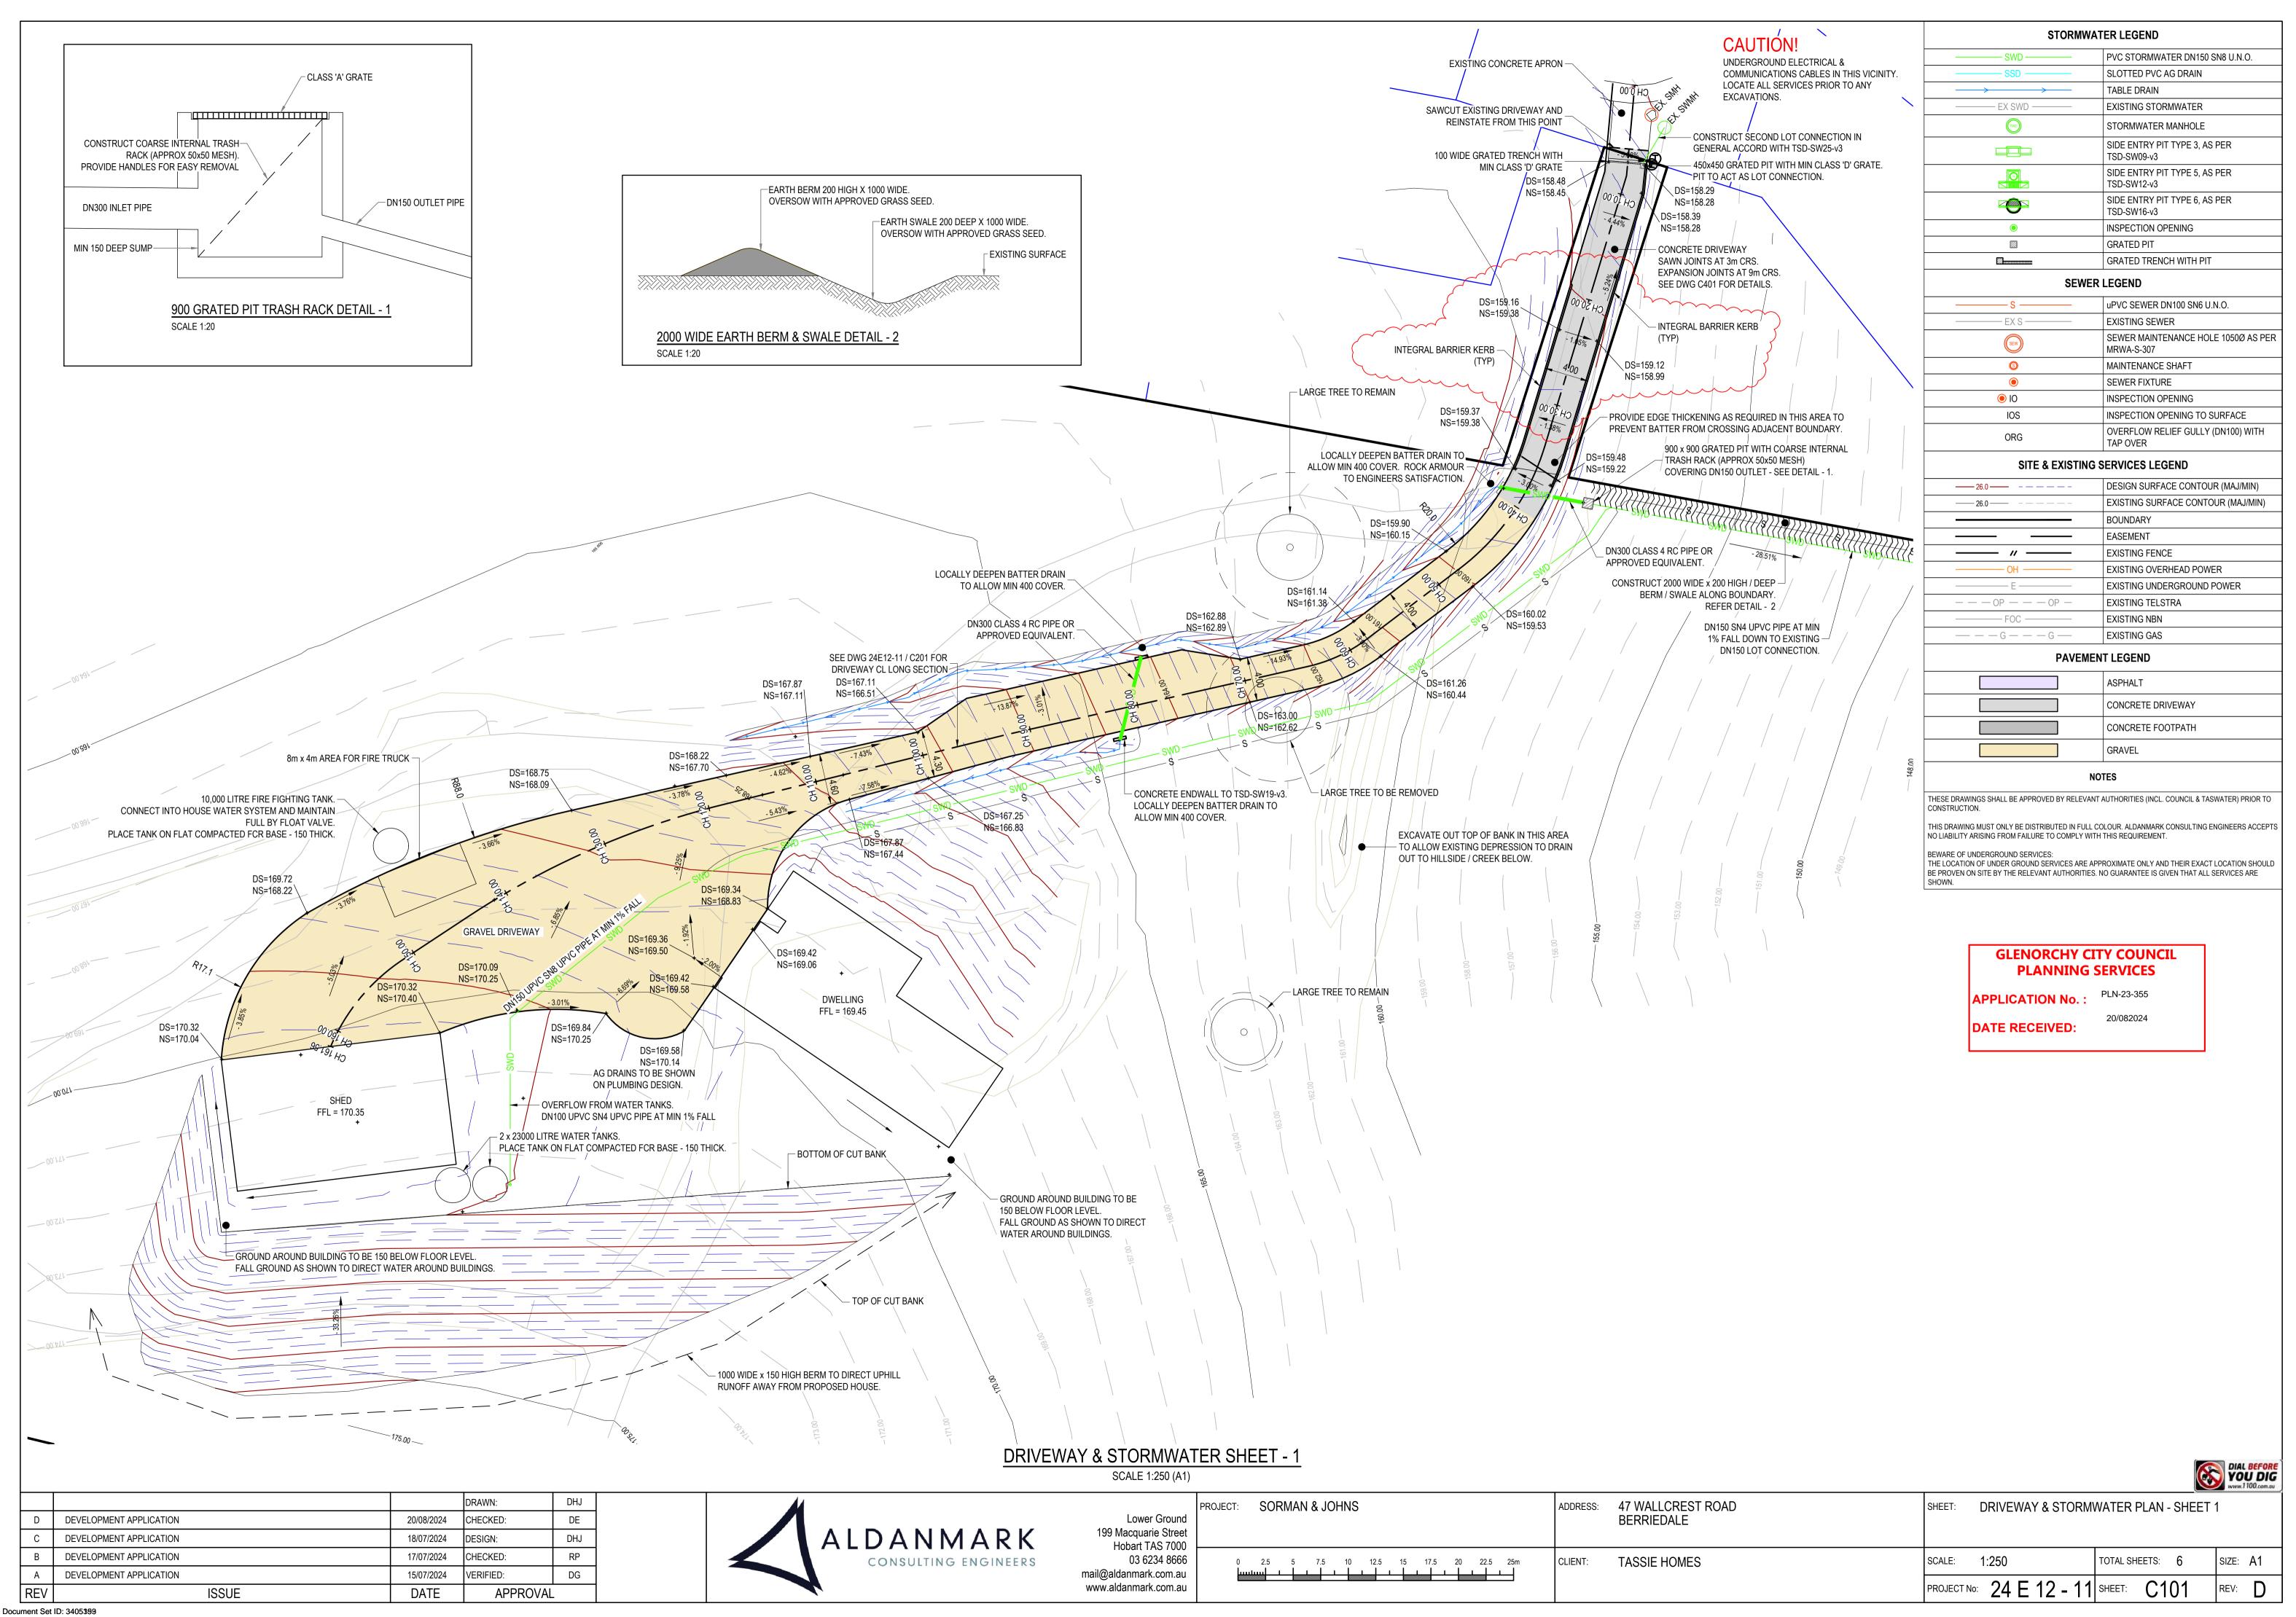

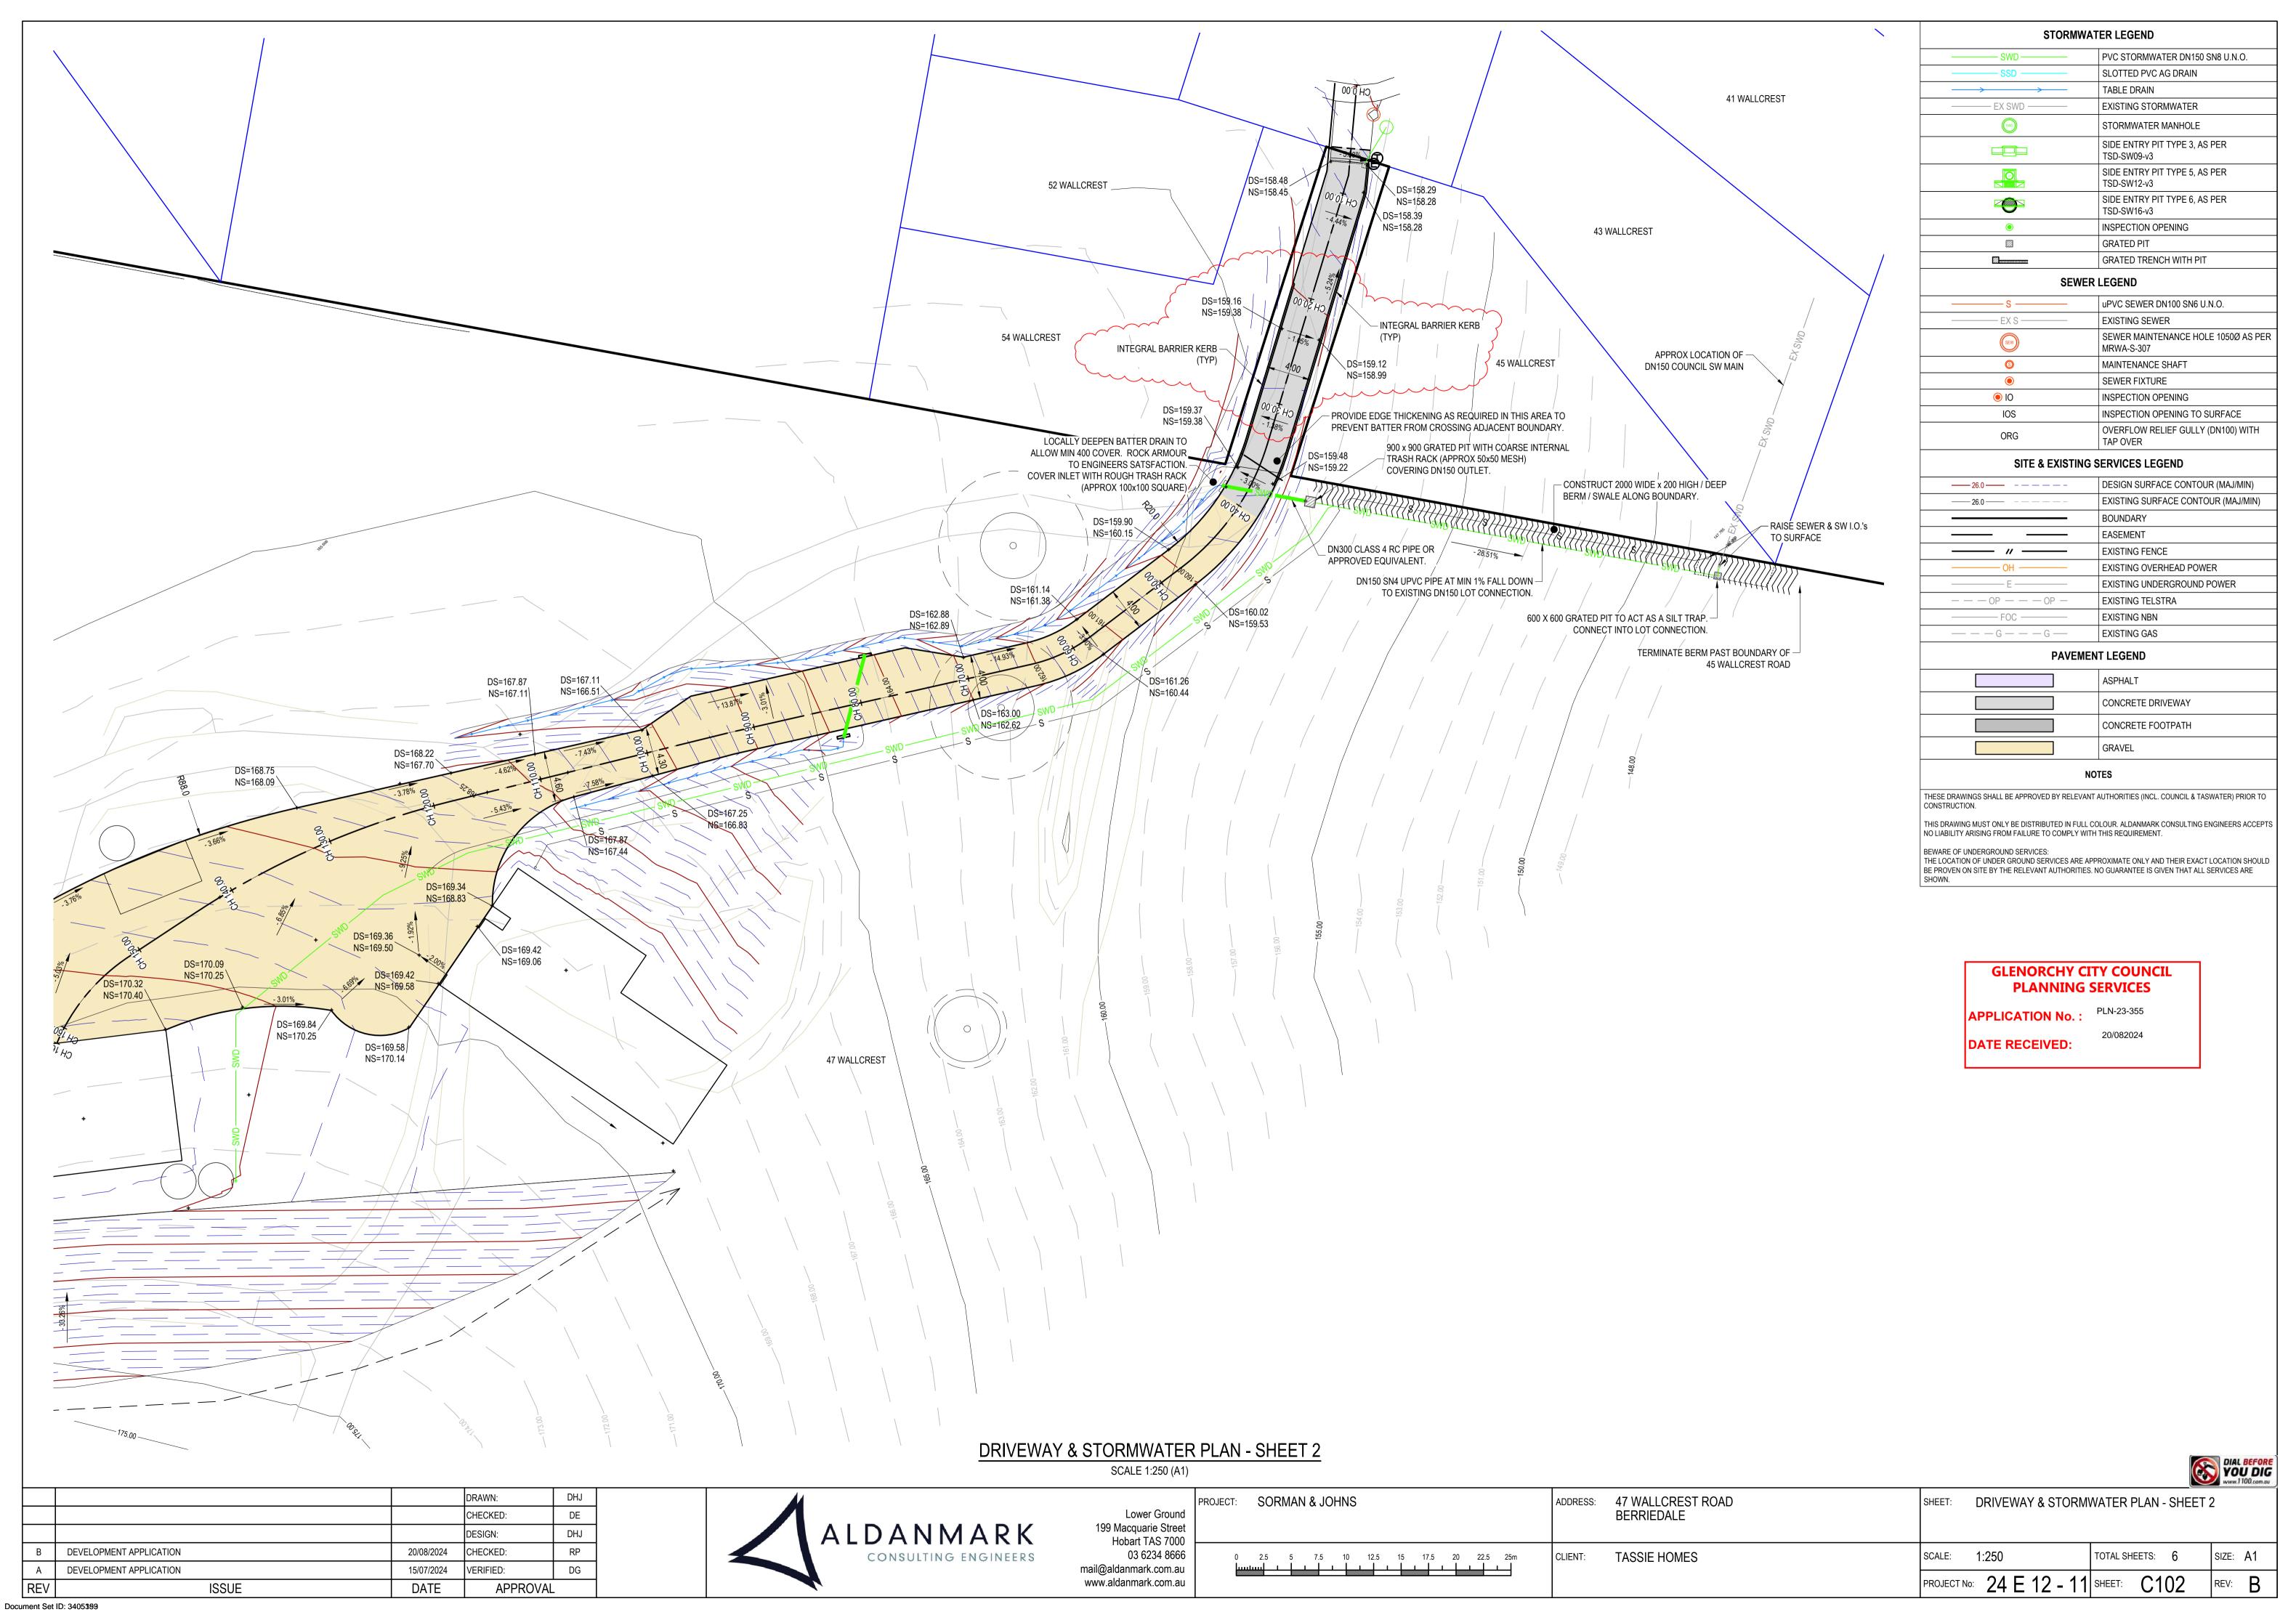

NOTES

THESE DRAWINGS SHALL BE APPROVED BY RELEVANT AUTHORITIES (INCL. COUNCIL & TASWATER) PRIOR TO CONSTRUCTION.

THIS DRAWING MUST ONLY BE DISTRIBUTED IN FULL COLOUR. ALDANMARK CONSULTING ENGINEERS ACCEPTS NO LIABILITY ARISING FROM FAILURE TO COMPLY WITH THIS REQUIREMENT.

BEWARE OF UNDERGROUND SERVICES:


THE LOCATION OF UNDER GROUND SERVICES ARE APPROXIMATE ONLY AND THEIR EXACT LOCATION SHOULD BE PROVEN ON SITE BY THE RELEVANT AUTHORITIES. NO GUARANTEE IS GIVEN THAT ALL SERVICES ARE SHOWN

GLENORCHY CITY COUNCIL PLANNING SERVICES

20/082024

APPLICATION No.: PLN-23-355

DATE RECEIVED:

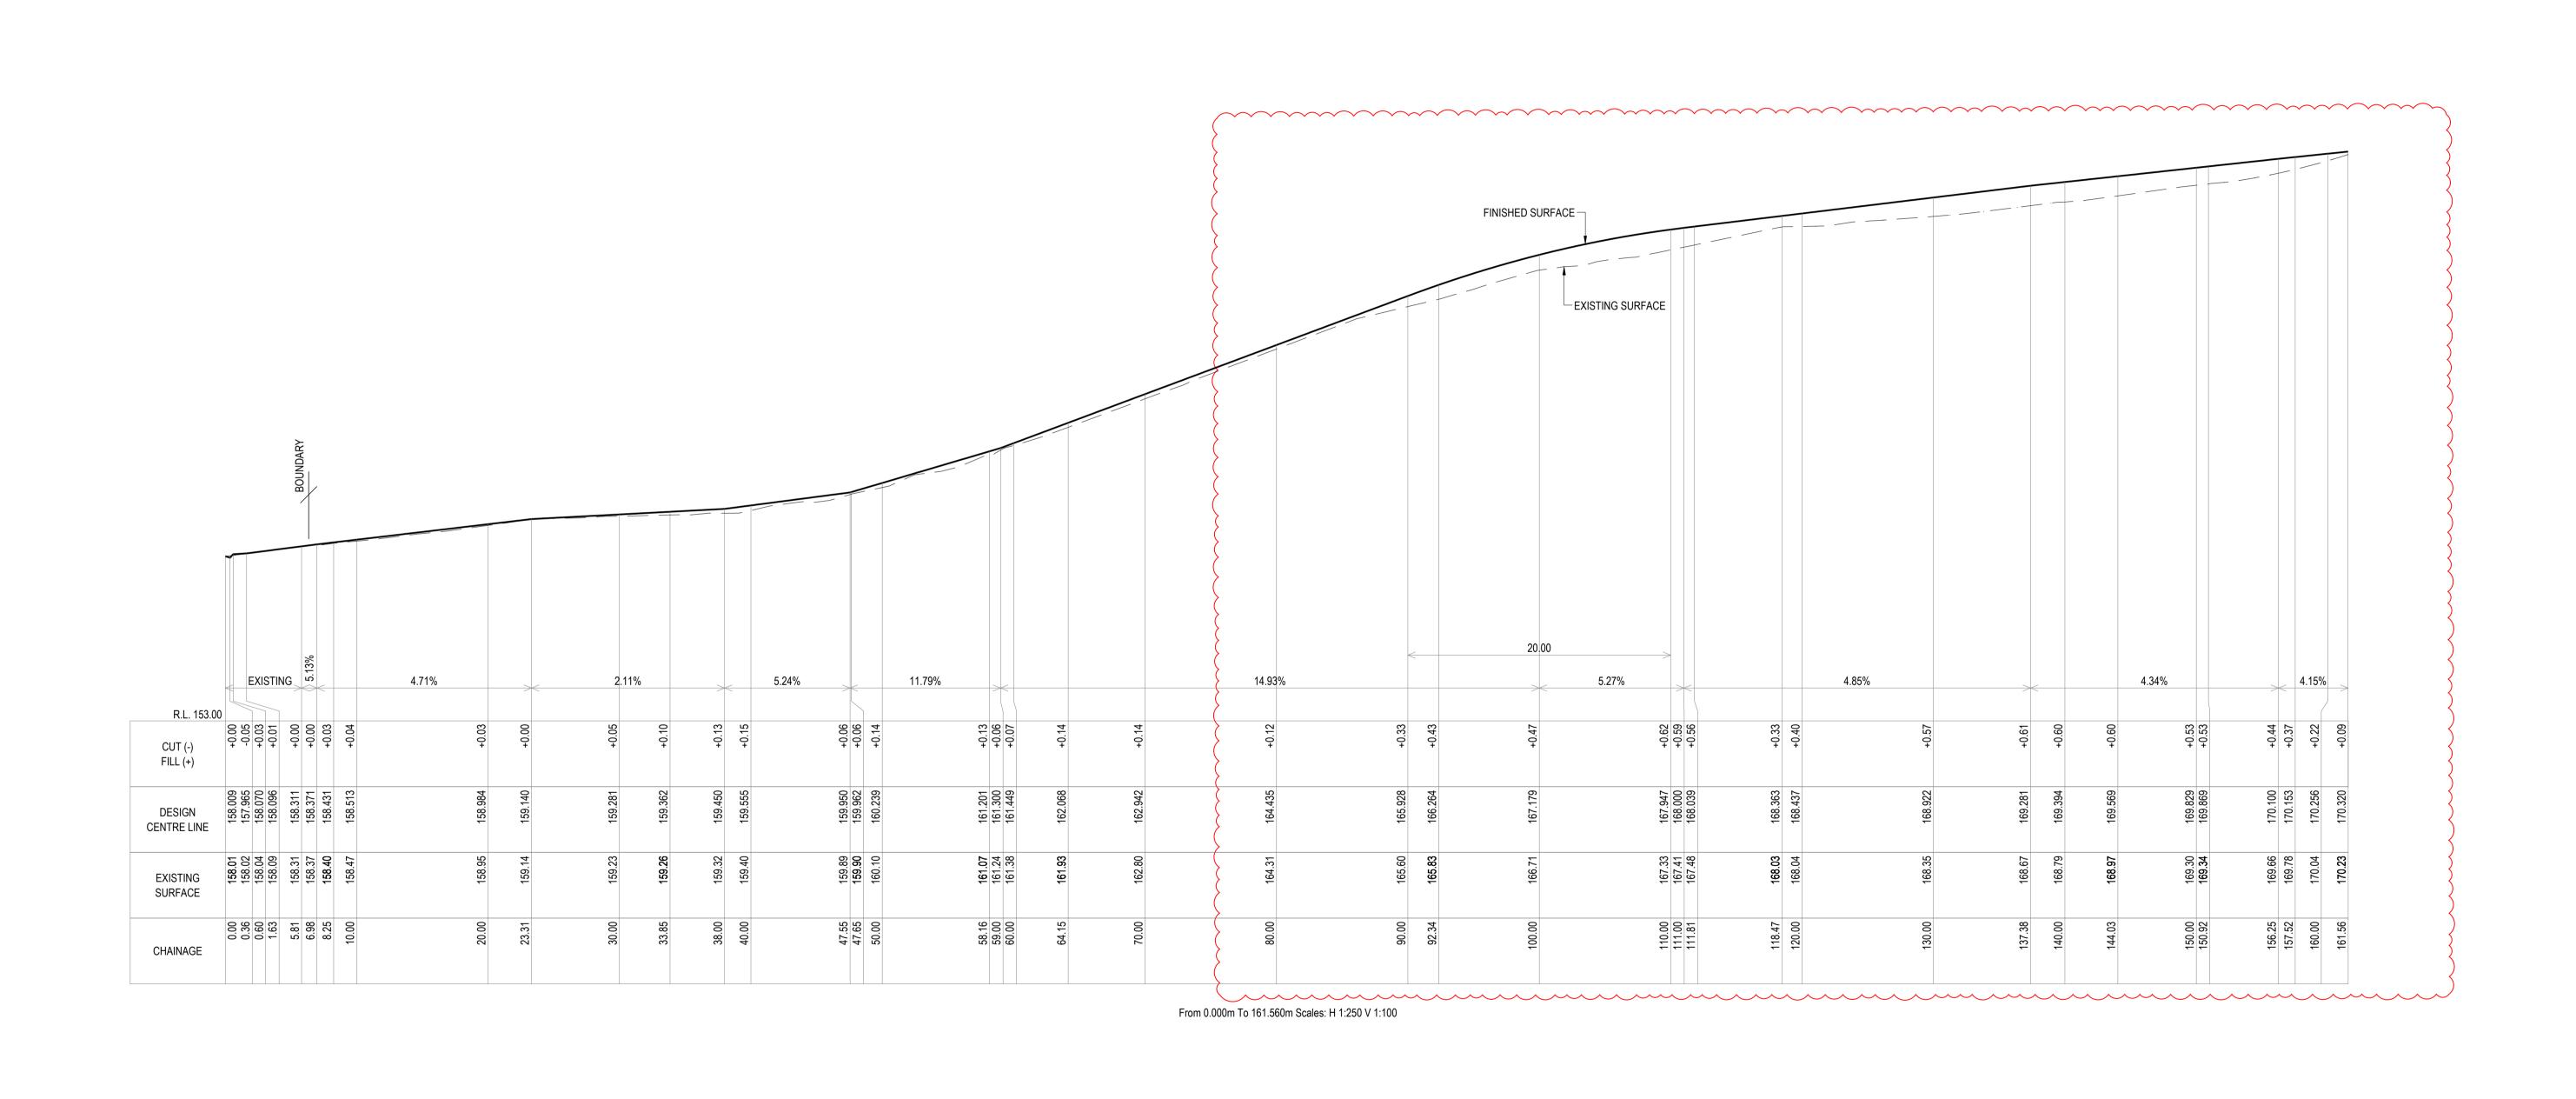


DRIVEWAY LONGITUDINAL SECTION SCALE HORIZ 1:250 VERT 1:100 (A1)


			DRAWN:	DHJ
			CHECKED:	DE
С	DEVELOPMENT APPLICATION	18/07/2024	DESIGN:	DHJ
В	DEVELOPMENT APPLICATION	17/07/2024	CHECKED:	RP
Α	DEVELOPMENT APPLICATION	15/07/2024	VERIFIED:	DG
REV	ISSUE	DATE	APPROVAL	





Lower Ground
199 Macquarie Street
Hobart TAS 7000
03 6234 8666
mail@aldanmark.com.au
www.aldanmark.com.au

d et	PROJECT:	SORMAN & JOHNS	ADDRESS:	47 WALLCREST ROAD BERRIEDALE	SHEET:	LONG SECTIONS - SH	EET 1	
6		0 5 10 15m H1:250	CLIENT:	TASSIE HOMES	SCALE:	AS INDICATED	TOTAL SHEETS: 6	SIZE: A1
u		0 1 2 3 4 5 6m			PROJECT N	· 24 E 12 - 11	SHEET: C201	REV: C

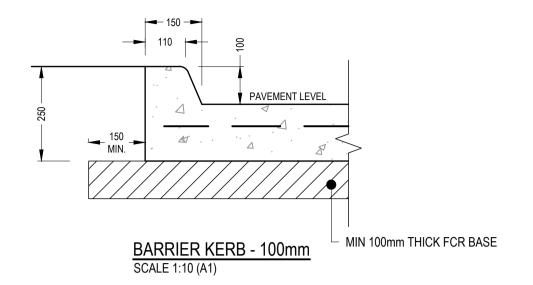


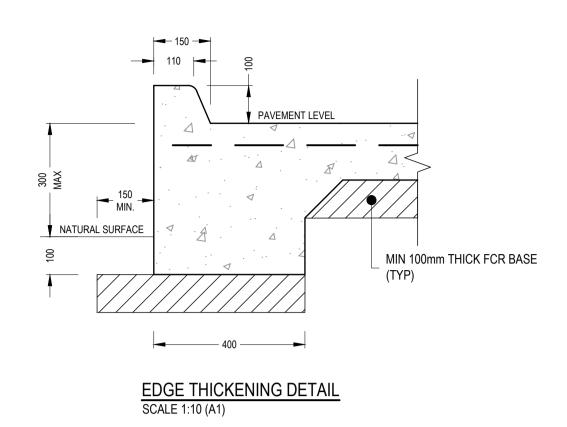

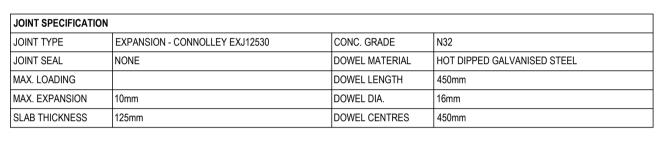

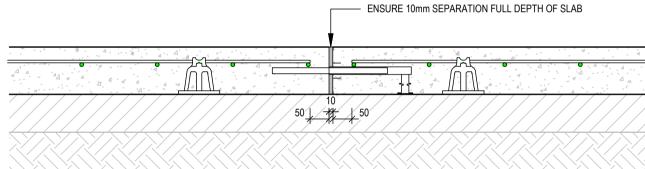

JT-EJ-02-001 - 125 EXPANSION JOINT

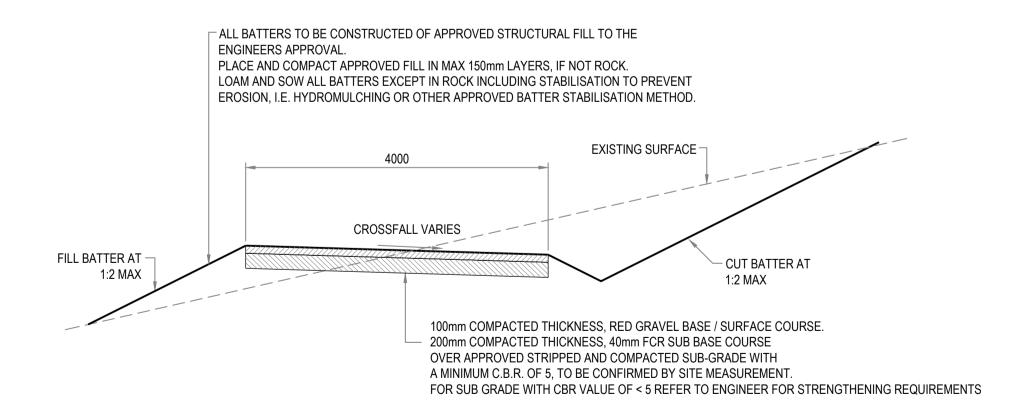

TYPICAL SECTION - GRAVEL DRIVEWAY SCALE 1: 50 (A1) SCALE 1: 100 (A3)

DETAILS AS INDICATED

			DRAWN:	DHJ	
			CHECKED:	DE	
			DESIGN:	DHJ	
			CHECKED:	RP	
Α	DEVELOPMENT APPLICATION	15/07/2024	VERIFIED:	DG	
REV	ISSUE	DATE	APPROVAL	-	



	Lower Grour
	199 Macquarie Stre
	Hobart TAS 700
	03 6234 866
ma	il@aldanmark.com.a
	ww.aldanmark.com.a

PROJECT:	SC	ORM	IAN	& J	OHI	NS						
0	1		2	3		4	5	6	7	8	9	10m
ш	<u></u>											<u>-</u>

SS:	47 WALLCREST ROAD BERRIEDALE	
	TASSIE HOMES	

CLIENT:

SHEET: DETAILS SCALE: AS INDICATED TOTAL SHEETS: 6 PROJECT No: 24 E 12 - 11 SHEET: C401

NO LIABILITY ARISING FROM FAILURE TO COMPLY WITH THIS REQUIREMENT. BEWARE OF UNDERGROUND SERVICES:

THE LOCATION OF UNDER GROUND SERVICES ARE APPROXIMATE ONLY AND THEIR EXACT LOCATION SHOULD BE PROVEN ON SITE BY THE RELEVANT AUTHORITIES. NO GUARANTEE IS GIVEN THAT ALL SERVICES ARE

NOTES

THESE DRAWINGS SHALL BE APPROVED BY RELEVANT AUTHORITIES (INCL. COUNCIL & TASWATER) PRIOR TO

THIS DRAWING MUST ONLY BE DISTRIBUTED IN FULL COLOUR. ALDANMARK CONSULTING ENGINEERS ACCEPTS

CONSTRUCTION.

GLENORCHY CITY COUNCIL PLANNING SERVICES APPLICATION No. : PLN-23-355

20/082024 DATE RECEIVED:

JOINT SPECIFICATION JOINT TYPE CRACK CONTROL CONC. GRADE JOINT SEAL NONE DOWEL MATERIAL N/A MAX. LOADING DOWEL TYPE DOWEL WIDTH N/A REINFORCEMENT SL82 SLAB THICKNESS 125mm DOWEL CENTRES N/A NOM. 3mm WIDE SAWCUT TO 1/3 SLAB DEPTH CONSTRUCT MAX. 18 HRS AFTER POUR LOCALLY SAG REO TO PROVIDE 25mm COVER BENEATH SAWCUT

JT-SJ-01-001 - 125 SAWCUT JOINT

125mm MIN. CONCRETE (N32) SL82 REINFORCING TOP (30mm

NOTE: CONCRETE PAVEMENT NOT DESIGNED FOR SPECIAL SURFACE FINISHES SUCH AS EXPOSED AGGREGATE.

CONCRETE PAVEMENT DETAIL

SL82 REINFORCING TOP (30mm COVER)

40mm SAWCUTS AT MAX. 4.0m CRS

100mm BASE A, 20mm FCR

APPROVED SUBGRADE

Version: 1, Version Date: 20/08/2024

Document Set ID: 3405399