

DEVELOPMENT APPLICATION

APPLICATION NUMBER: PLN-24-300

PROPOSED DEVELOPMENT: Single Dwelling

LOCATION: 183 Chapel Street Glenorchy

APPLICANT: Cmh Industries Pty Ltd

ADVERTISING START DATE: 11/12/2024

ADVERTISING EXPIRY DATE: 03/01/2025

Plans and documentation are available for inspection at Council's Offices, located at 374 Main Road, Glenorchy between 8.30 am and 5.00 pm, Monday to Friday (excluding public holidays) and the plans are available on Glenorchy City Council's website (www.gcc.tas.gov.au) until 03/01/2025.

During this time, any person may make representations relating to the applications by letter addressed to the Chief Executive Officer, Glenorchy City Council, PO Box 103, Glenorchy 7010 or by email to gccmail@gcc.tas.gov.au.

Representations must be received by no later than 11.59 pm on **03/01/2025**, or for postal and hand delivered representations, by 5.00 pm on **03/01/2025**.



CREATIVE HOMES HOBART, CNR OF ELWICK ROAD & BROOKER HIGHWAY, GLENORCHY 7010 PH: 03 6272 3000

PROJECT ADDRESS: LOT 4, 183 CHAPEL STREET, GLENORCHY

TITLE REFERENCE: VOLUME: 186202 FOLIO: 4

CLIENTS: CHH

DESIGNER: Inge Brown, CC 6652

DRAWINGS: 01 COVER PAGE

> 02 PROPOSED SITE PLAN 03 PROPOSED FLOOR PLAN 04 PROPOSED ROOF PLAN 05 PROPOSED ELEVATIONS 06 PROPOSED ELEVATIONS

07 SECTION A-A

08 TYPICAL SECTION DETAILS 09 WINDOW SCHEDULE

FLOOR AREAS: FLOOR AREA:

133.1 m²

PORCH:

DECK:

 $1.5 \, \mathrm{m}^2$

TOTAL AREA:

134.6 m² 13.5 m²

SOIL CLASSIFICATION: --

WIND CLASSIFICATION: --

CLIMATE ZONE: 7

BUSHFIRE ATTACK LEVEL: TBC

ALPINE AREA: N/A

CORROSION ENVIRONMENT: N/A

GLENORCHY CITY COUNCIL PLANNING SERVICES

APPLICATION No PLN-24-300

DATE RECEIVED .04/12/2024

DOCUMENTATION INDEX


The documentation listed below should be read in conjunction with these drawings and form the basis of construction documentation for the project

Document	Revision	Ву
Working drawings planning issue (these drawings)	D	Creative Homes Hobart
Survey plan SP24133-01	Α	Survey Plus
Soil assessment		Doyle Soil Consulting

GENERAL NOTES: LEGEND SITE PREPARATION THE SITE IS TO BE DISTURBED AS MINIMALLY AS -24m² PRIMARY PRIVATE 1. THIS PLAN HAS BEEN PREPARED BY SURVEY PLUS FROM A OPEN SPACE (DASHED LINE) MHA = Stormwater Manhole SRE = Sewer Rod Eye SWLC = Stormwater Lot Connection POSSIBLE TO THE EXTENT REQUIRED TO CARRY OUT COMBINATION OF EXISTING RECORDS AND FIELD SURVEY FOR WITH MINIMUM 4M Top RL:75.14 Ton RI:74.81 THE BUILDING WORKS SLC = Sewer Lot Connection DIMENSION MAX 1:10 THE PURPOSES OF SHOWING THE PHYSICAL FEATURES OF THE EARTHWORKS SHALL BE CARRIED OUT IN ACCORDANCE WITH NCC PART 3.2. In Inv A RL:73.53 Inv RL:74.36 CLC = Communication Lot Connection SLOPE (LEVEL AS REQUIRED) LAND AND SHOULD NOT BE USED FOR ANY OTHER PURPOSE. In Inv B RL:72.89 UN-RETAINED EMBANKMENT GRADIENTS SHALL BE IN COUNCIL REQUIREMENTS SWRE = Stormwater Rod Eye Out Inv RL:72.71 ACCORDANCE WITH NCC TABLE 3.2.1 2. TITLE BOUNDARIES SHOWN WERE NOT VERIFIED OR MARKED MH1 = Sewer Manhole DRAINAGE SHALL BE IN ACCORDANCE WITH NCC Top RL:75.20 BY SURVEY PLUS AT THE TIME OF THIS SURVEY. Top RL:76.11 -EXISTING STORMWATER SLC = Sewer Lot Connection Inv RL:74.00 In Inv RL:73.88 LOT CONNECTION PIPE THE BUILDER AND SUBCONTRACTOR SHALL ENSURE 3. SERVICES SHOWN ON THIS PLAN WERE LOCATED WHERE SIZE TO BE UPGRADED THAT ALL STORMWATER DRAINS, SEWER PIPES AND THE LIKE ARE LOCATED AT A SUFFICIENT DISTANCE Top RL:75.25 Out Inv RI:73.86 POSSIBLE BY FIELD SURVEY. THEY ARE NOT A COMPLETE PICTURE TO 150mm DIAMFTER Inv RL:74.48 PROPOSED GRATED DRAIN PIPE IN ACCORDANCE CAR PARKING SPACE 2.4 X 5.5M OF SERVICES ON SITE. ALL SERVICE LOCATIONS ARE TO BE FROM ANY BUILDINGS FOOTING AND/OR SLAB EDGE BEAMS SO AS TO PREVENT GENERAL MOISTURE WITH SUMP CONNECTED AT MAX GRADIENT 1: 20 PARALLEL TO WITH COUNCIL AND MH2 = Sewer Manhole VERIFIED BEFORE COMMENCEMENT OF ANY WORK ON SITE, IN TO STORMWATER TO **TASWATER** PARKING ANGLE SWLC = Stormwater Lot Connection PENETRATION, DAMPNESS, WEAKENING & Top RL:74.84 PARTICULAR THOSE SERVICES NOT PREVIOUSLY LOCATED ENGINEER'S FUTURE DETAIL AND CONSTRUCTED IN ACCORDANCE REQUIREMENTS Top RL:75.21 UNDERMINING OF ANY BUILDING AND IT'S FOOTING In Inv RL:74.12 THROUGH FIELD SURVEY WITH AS2890.1 14820 11265 Inv RL:74.04 Out Inv RL:74.11 CONCRETE SLAB TO-LOCATION OF ALL EXISTING SERVICES TO BE CONFIRMED ON SITE PRIOR TO CONSTRUCTION. ENGINEER'S DETAILS 4. SURVEY PLUS CAN NOT ACCEPT LIABILITY WHATSOEVER FOR ATTENTION OF OWNER LOSS OR DAMAGE CAUSED TO ANY UNDERGROUND SERVICE THE OWNERS ATTENTION IS DRAWN TO THE FACT THAT BDY A #COMPILED BOUNDARY 48°02' 3.21/1 WHETHER SHOWN BY OUR SURVEY OR NOT. FOUNDATIONS AND ASSOCIATED DRAINAGE FOR ALL SITES REQUIRES CONTINUING MAINTENANCE TO 5. THIS NOTE IS AN INTEGRAL PART OF THIS PLAN/DATA ASSIST FOOTING PERFORMANCE, ADVICE FOR FOUNDATION MAINTENANCE IS CONTAINED IN THE √EASEMENT C = PIPEL√ÍNE_& SERVICES EASEMÉNT 3.00 WIDE & REPRODUCTION OF THIS PLAN OR ANY PART OF IT WITHOUT THIS CSIRO BUILDING TECHNOLOGY FILE 18 AND IT IS THE OWNERS RESPONSIBILITY TO MAINTAIN THE SITE IN NOTE BEING INCLUDED IN FULL WILL RENDER THE INFORMATION **B85 TURNING PATH** SHOWN ON SUCH A REPRODUCTION INVALID AND NOT SUITABLE FOR USE WITHOUT PRIOR AUTHORITY OF SURVEY PLUS. SLC SOIL AND WATER MANAGEMENT NOTES: DRAINAGE LINES ARE TO BE INSTALLED PRIOR TO THE €ÖMPILFD BOUNDARY SWLC 288°587 ∕26.72m 6. HORIZONTAL DATUM IS MGA (GDA94). PLACEMENT OF ROOF AND GLITTERING, ONCE DWELLING IS ROOFED, CONNECT IMMEDIATELY EX. CORNER MARK 7. VERTICAL DATUM IS AHD. APPLY TEMPORARY COVERING TO DISTURBED AREAS THAT WILL REMAIN EXPOSED FOR 14 DAYS OR MORE 2 Star, Picket DURING CONSTRUCTION (EG. WATERPROOF 8. CONTOUR INTERVAL IS 0.2 METRE, INDEX IS 1.0 METRE. RL:75.15/ BLANKET, VEGETATION OR MULCH) 5 PROTECT ANY NEARBY OR ON-SITE DRAINAGE PITS 9. SURVEY BY ROBOTIC TOTAL STATION AND GPS. FROM SEDIMENT BY INSTALLING SEDIMENT TRAPS AROUND THEM. 10 DUE TO THE AGE OF TITLE SURVEY IF ANY CONSTRUCTION DRIVEWAY LIMIT ENTRY/EXIT TO ONE POINT AND STABILISE. WORKS ARE TO BE UNDERTAKEN ON OR NEAR THE TITLE BOUNDARY OR PRESCRIBED SETBACKS A RE-MARK SURVEY WILL 51 9m² INSTALL FACILITIES TO REMOVE DIRT/ MUD FROM VEHICLE WHEELS BEFORE THEY LEAVE THE SITE. Water BE REQUIRED SITE TO BE VEGETATED AND PLANTED ACCORDING TO THE HOBART REGIONAL SOIL AND WATER Q 7 11. IMPORTED DATA SHOWN ON THIS PLAN WAS OBTAINED FOR MANAGEMENT CODE OF PRACTICE. PUBLIC AVAILABLE DATA FROM VARIOUS GOVERNMENT DECK BUILDER AND SUBCONTRACTORS TO VERIFY ALL AUTHORITIES. THIS INFORMATION IS PROVIDED FOR GUIDANCE FFL RL. 76.45 **DIMENSIONS AND LEVELS** PRIOR TO THE COMMENCEMENT OF ANY WORK. GIVE 24 HOURS ONLY. THE ACCURACY OF ANY IMPORTED DATA IS PER THE PROPOSED RESIDENCE ACCURACY QUOTED BY THE SOURCE AND IS IN NO WAY MINIMUM NOTICE WHERE AMENDMENTS ARE REQUIRED TO DRAWINGS. THESE DRAWINGS ARE TO GUARANTEED BY SURVEY PLUS. USERS MUST NOT RELY ON THIS LOT 4, 183 CHAPEL STREET BE READ IN CONJUNCTION WITH DOCUMENTATION DATA FOR ON-GROUND LOCATION OF BOUNDARIES AND/OR FFL RL./76.45 LISTED ON THE COVER PAGE. DO NOT SCALE FFL RL. 76.50 DIMENSIONS ARE TO TAKE PREFERENCE OVER SCALE. LIST DATA IMPORT BUILDING SPECIFICATION AND ENGINEERS DRAWINGS SHALL OVERRIDE ARCHITECTURAL TasWater-SewerLateralLine TasWater-SewerMain TasWater-SewerMaintenanceHole -THIS DRAWING IS TO BE READ IN CONJUNCTION WITH ALL OTHER DRAWING SHEETS, CONSULTANTS DRAWINGS, DOCUMENTS, SCHEDULES AND TasWater-SewerPressurisedMain TasWater-WaterHydrant SPECIFICATIONS (AS APPLICABLE). -THE BUILDER AND SUBCONTRACTOR SHALL ENSURE TasWater-WaterLateralLine COMPILED BOUNDARY 288°42' 29.20m TasWater-WaterMain THAT ALL STORMWATER DRAINS, SEWER PIPES AND THE LIKE ARE LOCATED AT A SUFFICIENT DISTANCE CadastralParcel-OwnerInformation OPEN SPACÉ FROM ANY BUILDINGS FOOTING AND/OR SLAB EDGE BEAMS SO AS TO PREVENT GENERAL MOISTURE LOCAL COUNCIL IMPORT ELECTRICITY TRANSMISSION INNER PROTECTION AREA PENETRATION, DAMPNESS, WEAKENING & LocalAuthority-StormwaterMain UNDERMINING OF ANY BUILDING AND ITS FOOTING POWER LINE INFRASTRUCTURE 12. BOUNDARIES ARE COMPILED ONLY FROM SP186202 AND 5131EM. - LOCATION OF ALL EXISTING ONSITE SERVICES TO BE CONFIRMED ONSITE PRIOR TO CONSTRUCTION RELEVANT SURVEY INFORMATION OBTAINED FROM LAND TITLES OFFICE AND ARE APPROXIMATE AND SUBJECT TO SURVEY. IMPORTANT! Elec. Pole SITE INFORMATION AS DRAWN IS APPROXIMATE 13. 3D DATA TURNED OFF IN LAYER CONTROL ONLY. FINAL SITE INFORMATION IS SUBJECT TO A Stay Wire Fler Pole 3D TIN DETAILED CONTOUR SURVEY BY LICENSED Highest Wire RL:86,34 MAJOR CONTOUR 3D SURVEYOR MINOR CONTOUR 3D 12495 15820 **DP 90mm DOWNPIPE** GPS DATA SCALE LOCATION SOIL CLASSIFICATION: JOB CONTROL POINT NOTE: ALL PROPOSED STORMWATER OPOSED STORMWATER-**GLENORCHY CITY COUNCIL** YOUT CONCEPT - TO POINT NO: #1 WIND CLASSIFICATION: **INFRASTRUCTURE** GINEER'S FUTURE DETAIL DESCRIPTION: SPM9607 EROSION AND SEDIMENT CONTROL MEASURES ARE TO BE IMPLEMENTED ON THE SITE IN ACCORDANCE WITH COUNCIL REQUIREMENTS PLANNING SERVICES LOT SERVICES UNABLE TO BE LOCATED: GPS SCALE FACTOR = 1.000406625 SITE COVERAGE E: 521089.641 - NO COMMUNICATIONS LOT CONNECTION SITE AREA 466.7 m² N: 5256449.806 **APPLICATION No PLN-24-300** RL: 75.974 PROPOSED BUILDING FOOTPRINT 134.6 m² PROPOSED SITE PLAN FPU = 0.04 +PROPOSED SITE COVERAGE 28.84 % **DATE RECEIVED** .04/12/2024. JOB ADDRESS: CLIENT PRFILMINARY Lot 4, 183 Chapel Street CHH © COPYRIGHT IN WHOLE OR IN PART Glenorchy REV: DESCRIPTION: DATE: BY: CONTRACTOR MUST VERIFY ALL DIMENSIONS designer: I. Brown accred. no.: CC6652 sheet: 2 of 9 AND LEVELS AT THE JOB PRIOR TO COMMENCING B ISSUED FOR CLIENT REVIEW NN 26/11/24 DRAWN:N. Nguyen | DATE: October 2024 DESIGN TYPE: Custom ANY WORK OR MAKING ANY SHOP DRAWINGS. ISSUED FOR CLIENT REVIEW NN 28/11/24 CHECKED: DRAWING NO: DATE D UPDATE WALK IN SHOWER |NN|29/11/24 DO NOT SCALE DRAWINGS. CREATIVE HOMES HOBART, CNR OF ELWICK ROAD & BROOKER HIGHWAY, GLENORCHY 7010 PH: 03 6272 3000 ALWAYS USE WRITTEN DIMENSIONS 1:200 REV: SCALE E COUNCIL RFI Version: 1, Version Date: 09/12/2024

AREAS: FLOOR AREA: 133.1 m² PORCH: TOTAL AREA: 134.6 m² DECK: 13.5 m²

LEGEND: DOWNPIPE LOCATION SHOWER SHR BTH BATH IVВ VANITY BASIN WC TOILET OVERHEAD CUPBOARDS ОНС **IREF** REFRIGERATOR RANGE HOOD UBO UNDER BENCH OVEN COOK TOP ĎW DISH WASHER **TROUGH** WM **WASHING MACHINE** MANHOLE lмн CAVITY SLIDING DOOR CSD ALUM. AWNING WINDOW AAW ALUM, FIXED WINDOW ALUM. SLIDING DOOR ASD **REAM OVER** R/O BALUSTRADE WALK IN SHOWER BAL SELECTED BALUSTRADE TO BUILDER'S STANDARD DETAIL INSTALLED IN ACCORDANCE MASONRY ARTICULATION IOINT - LOCATION TO ENGINEER'S DETAILS CEILING MOUNTED INTERCONNECTED SMOKE DETECTORS, MAINS WIRED WITH BATTERY BACKUP, ALL IN ACCORDANCE WITH AS 3786. 90mm DOWNPIPE

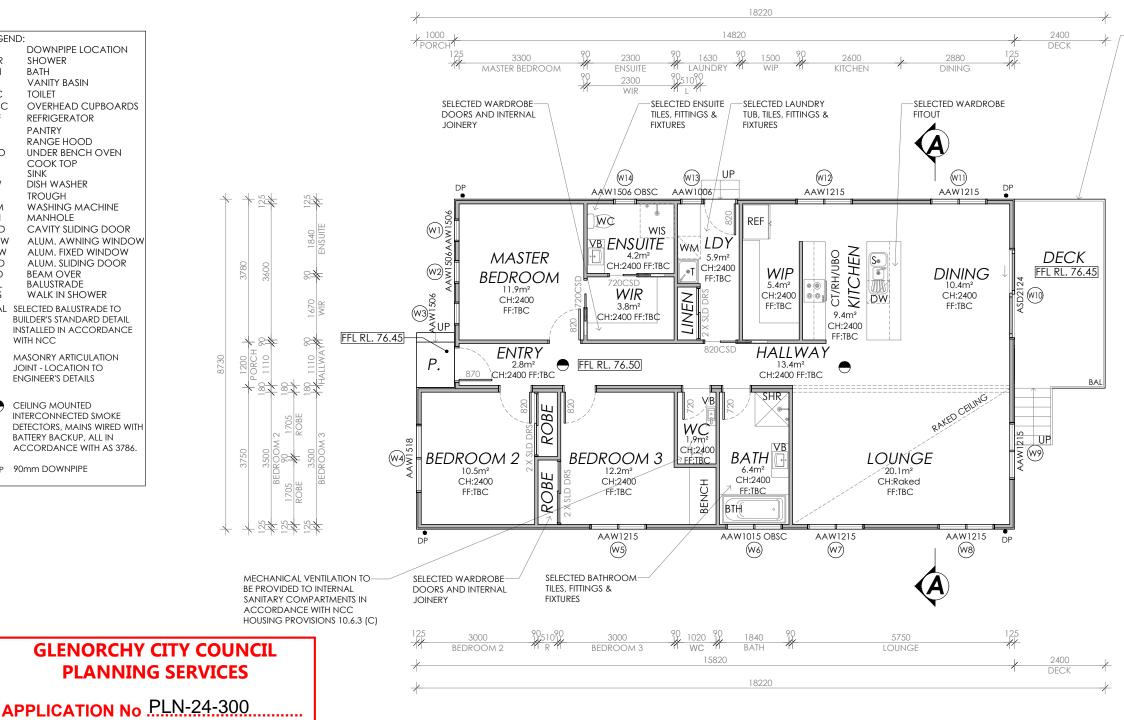

-SELECTED TIMBER DECK WITH STAIR AND BALUSTRADE TO ENGINEER'S DETAILS AND INSTALLED IN ACCORDANCE WITH NCC PART 11 & PART 12.3 (ATTACHMENT TO BUILDING)

BALUSTRADE TO BE IN ACCORDANCE WITH NCC HOUSING PROVISIONS PART 11.3 AND BE CAPABLE OF BEARING LOADING FORCES ACCORDING TO AS1170.1 & AS 4586 SLIP RESISTANCE OF TREADS TO COMPLY WITH NCC HOUSING PROVISIONS 11.2.4

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87 84

RISER: 190mm (max) GOING: 250mm 2R+G: 630mm (SLOPE RELATIONSHIP)

Builder and subcontractors to verify all dimension and levels prior to the commencement of any work. Give 24hrs minimum notice where amendments are required to design of working drawings. These drawings are to be read in conjunction with Engineer's and Surveyor's drawings and notes. Do not scale drawings. Dimensions are to take preference over scale. Building specification and Engineer's drawings shall override architectural drawings. All construction work shall be carried out in accordance with the state building regulations, local council by-laws and relevant NCC and AS codes.

Framing NCC H1D6
All timber framing, fixing and bracing shall comply with A\$ 1884 and the requirements of NCC H1D6.
Manufactured sizes must not be undersized to those specified, for all timber sizes, stress grades, spacing and wall bracing refer to Engineer's details. Tie-down details shall be in accordance with Engineer's details and comply with

rie-down derlais shall be in accordance with Engineer's details and comply with NCC H1D6 (4). Structural steel members shall comply with the requirements of clauses in NCC H1D6 (3). Refer to Engineer's details where provided.

Glazing NCC H1D8 All windows to be aluminium awning style, double glazed (obscured safety glass to bathrooms as shown on drawings) All glazing shall comply with the requirements of AS 2047 & AS 1288 and NCC H1D8.

Human impact safety requirements shall comply with NCC H1D8 (3) and Part 8.4 of the ABCB Housing provisions.

Builder and subcontractors to verify all

Important notice for attention of Owners: the Owners attention is drawn to the fact that foundations and associated drainage in all sites requires continuing maintenance to assist tooting performance. Advice for foundation maintenance is contained in the CSIRO building technology file 18 and it is the Downers responsibility to maintain the site in accordance with this document.

Energy efficiency:
Insulation must comply with AS/NIZ\$4859.1
and be installed in accordance with
ABCB housing provisions Part 13.2.2 and
comply with minimum R values for
climate zone 7.
Bulk insulation between external studs to

be insulated with min R2.0. (Ensure batts fit within cavity without compression, making sure that there is at least 25mm gap from the reflective surface). External walls are to be clad with vapour permeable reflective foil over the outside of the timber frame. Ceiling to be insulated with R4.0 and vapour permeable sarking. Floor to be insulated with Min R1.7 batts where applicable. Seal exhaust fans to Ensuite, Bathroom Laundry and Kitchen. All downlights to be IC rated. Construction of the externa walls, floor and roof for compliance with building sealing requirements shall comply with BCA 2019 Part 3.12

General:
All flashings, weep holes and damp proof coursing to be in accordance with NCC Housing provisions Part 5.7. Fibre cement sheet in accordance with NCC Housing provisions Part 7.5. Block construction in accordance NCC Housing provisions Part 5. Plasterboard linings to internal walls and ceilings with selected cornice. (see below for wet areas)

Wet areas: All wet areas shall comply with the requirements of ABCB Housing provisions Part 10.2. Provide waterprool plasterboard sheeting to all walls and ceilings. Provide ceramic tiles or other ceilings. Provide Ceramic lies of other approved water resistant lining in accordance with Part 10.2.9 to a minimum height of 1 800mm to shower walls and to a height of min 150mm behind baths, basins, sinks, troughs, washing machines and wall fixtures.

For construction of floor wastes refer to NCC ABCB Housing provisions part 10.2.12. For typical installation requirements for substrate preparation, penetrations, flashings/junctions, membranes, screeds, hobs, baths, showers, door jambs and screens refer t ABCB Housing provisions part 10.2.14-32.

PROPOSED FLOOR PLAN

DATE RECEIVED .04/12/2024

FLOOR AREA: 134.6m²

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PROJECT NORTH DO NOT SCALE DRAWINGS.

CONTRACTOR MUST VERIFY ALL DIMENSIONS AND LEVELS AT THE JOB PRIOR TO COMMENCING ANY WORK OR MAKING ANY SHOP DRAWINGS.

REV: DESCRIPTION: DATE: BY: B ISSUED FOR CLIENT REVIEW NN 26/11/24 ISSUED FOR CLIENT REVIEW NN 28/11/24 UPDATE WALK IN SHOWER NN 29/11/24 ALWAYS USE WRITTEN DIMENSIONS E COUNCIL RFI

PRELIMINARY



	JOB ADDRESS:						
	Lot 4, 183 Chapel Street						
	Glenorchy						
5	DESIGNER:	I. Brown	ACCRED	. NO.: C			
-	DRAWN:N.	Nguyen	DATE:	Octob			

1:100

SCALE:

DATE:

REV:

CC6652 SHEET: October 2024 DESIGN TYPE:

Ε

CLIENT: CHH

3 of 9 Custom DRAWING NO:

GLENORCHY CITY COUNCIL PLANNING SERVICES

APPLICATION No PLN-24-300 **DATE RECEIVED** .04/12/2024

> -VAPOUR PERMEABLE SARKING OVER BATTENS (OR EQUIV.) (WITH 25MM SAG AIR GAP TO ROOFING) AND MINIMUM 10MM ROOF VENTILATION (SUPPLY) GAP IN ACCORDANCE WITH NCC SECTION H (TAS H4D9) AND ABCB HOUSING PROVISIONS 10.8.3 RIDGE TO HAVE CONTINUOUS GAP IN VAPOUR PERMEABLE SARKING (5mm) OR EQUIV. VENTILATION SYSTEM (EXHAUST)IN ACCORDANCE WITH NCC SECTION H (TAS H4D9) AND ABCB HOUSING PROVISIONS 10.8.3 -SELECTED COLORBOND ROOF INSTALLED TO MANUFACTURER'S SPECIFICATION -SELECT COLORBOND CAPPING AND FLASHINGS INSTALLED TO MANUFACTURER'S SPECIFICATION

> > -SELECT COLORBOND FASCIA AND

GUTTERING

Framing NCC H1D6
All timber framing, fixing and bracing shall comply with AS 1684 and the requirements of NCC H1D6.
Manufactured sizes must not be undersized to those specified, for all timber sizes, stress grades, spacing and wall bracing refer to Engineer's details. Tie-down details shall be in accordance with Engineer's details and comply with NCC H1D6 (4). Structural steel members shall comply with the requirements of clauses in NCC H1D6 (3). Refer to Engineer's details where provided.

Glazing NCC H1D8 All windows to be aluminium awning style, double glazed (obscured safety glass to bathrooms as shown on drawings) All glazing shall comply with the requirements of AS 2047 & AS 1288 and NCC H1D8.

Human impact safety requirements shall comply with NCC H1D8 (3) and Part 8.4 of the ABCB Housing provisions.

Builder and subcontractors to verify all Builder and subcontractors to verify all dimension and levels prior to the commencement of any work. Give 24hrs minimum notice where amendments are required to design of working drawings. These drawings are to be read in conjunction with Engineer's and Surveyor's drawings and notes. Do not scale drawings. Dimensions are to take preference over scale. Building specification and Engineer's drawings shall override architectural drawings. All construction work shall be carried out in accordance with the state building regulations, local council by-laws and relevant NCC and AS codes.

Important notice for attention of Owners: the Owners attention is drawn to the fact the Owners attention is drawn to the fact that foundations and associated drainage in all sites requires continuing maintenance to assist footing performance. Advice for foundation maintenance is contained in the CSIRO building technology file 18 and it is the Owners responsibility to maintain the site in accordance with this document.

Energy efficiency:
Insulation must comply with AS/NZ\$4859.1
and be installed in accordance with
ABCB housing provisions Part 13.2.2 and
comply with minimum R values for
climate zone 7.
Bulk insulation between external studs to
be insulated with min R2.0. (Ensure batts
fit within cavity without compression,
making sure that there is at least 25mm
gap from the reflective surface). External
walls are to be clad with vapour
permeable reflective foil over the outside
of the timber frame. Ceiling to be
insulated with R4.0 and vapour insulated with R4.0 and vapour permeable sarking. Floor to be insulated with Min R1.7 batts where applicable. Seal exhaust fans to Ensuite, Bathroom, Laundry and Kitchen. All downlights to be IC rated. Construction of the external

General: All flashings, weep holes and damp All flashings, weep holes and damp proof coursing to be in accordance with NCC Housing provisions Part 5.7. Fibre cement sheet in accordance with NCC Housing provisions Part 7.5. Block construction in accordance NCC Housing provisions Part 5.7. Plasterboard linings to internal walls and ceilings with selected cornice. (see below for wet great)

walls, floor and roof for compliance with building sealing requirements shall comply with BCA 2019 Part 3.12

Wet areas: All wet areas shall comply Wet areas: All wet areas shall comply with the requirements of ABCB Housing provisions Part 10.2. Provide waterproof plasterboard sheeting to all walls and ceillings. Provide ceramic tiles or other approved water resistant lining in accordance with Part 10.2.9 to a minimum height of 1800mm to shower walls and to a height of min 150mm behind baths, basins, sinks, troughs, washing machines and wall fixtures.

For construction of floor wastes refer to For construction of floor wastes reter to NCC ABCB Housing provisions part 10.2.12. For typical installation requirements for substrate preparation, penetrations, flashings/ junctions, membranes, screeds, hobs, baths, showers, door jambs and screens refer to ABCB Housing provisions part 10.2.14-32.

4 of 9

Custom

PROPOSED ROOF PLAN

DO NOT SCALE DRAWINGS.

ALWAYS USE WRITTEN DIMENSIONS.

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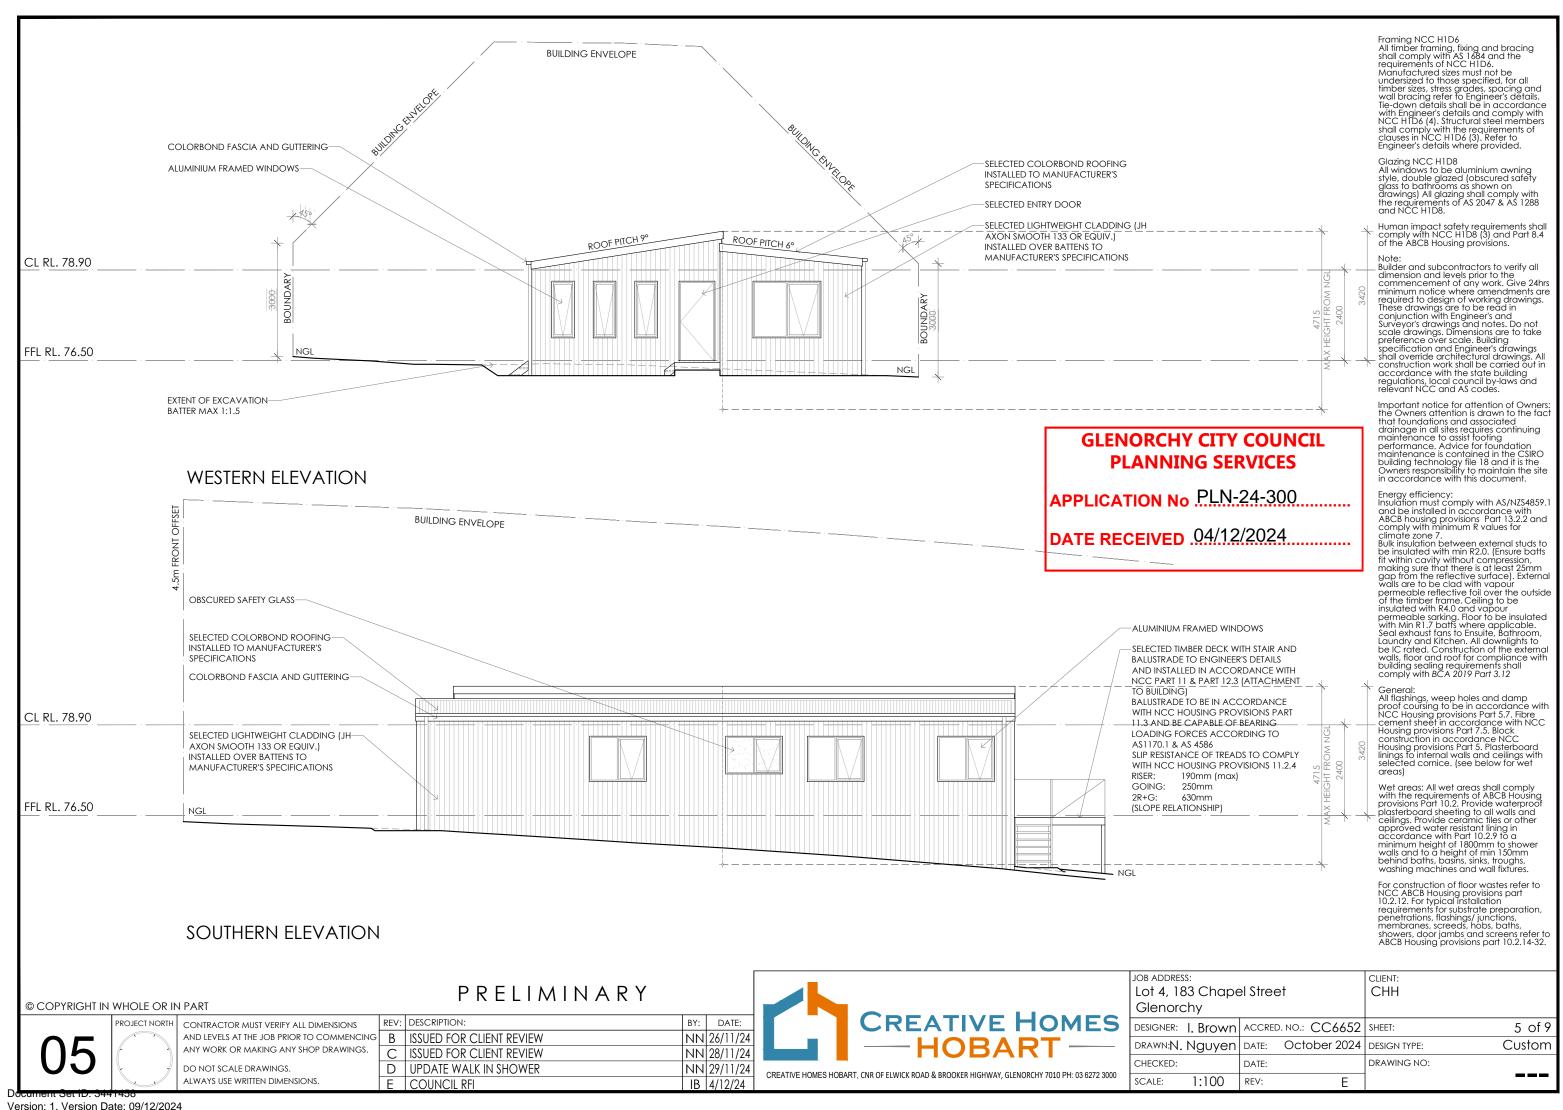
PROJECT NORTH


PRELIMINARY

REV: DESCRIPTION: DATE: BY: CONTRACTOR MUST VERIFY ALL DIMENSIONS B ISSUED FOR CLIENT REVIEW NN 26/11/24 AND LEVELS AT THE JOB PRIOR TO COMMENCING ANY WORK OR MAKING ANY SHOP DRAWINGS. ISSUED FOR CLIENT REVIEW NN 28/11/24 UPDATE WALK IN SHOWER NN 29/11/24 E COUNCIL RFI IB 4/12/24



◆ DP 90mm DOWNPIPE							
	JOB ADDRESS: Lot 4, 183 Chape Glenorchy	CLIENT: CHH					
5	designer: I. Brown	ACCR	ED. NO.: CC6652	SHEET:			
-	DRAWN:N. Nguyen	DATE:	October 2024	DESIGN TYPE:			
_	CHECKED:	DATE:		DRAWING NO:			
0	SCALE: 1:100	REV:	E				



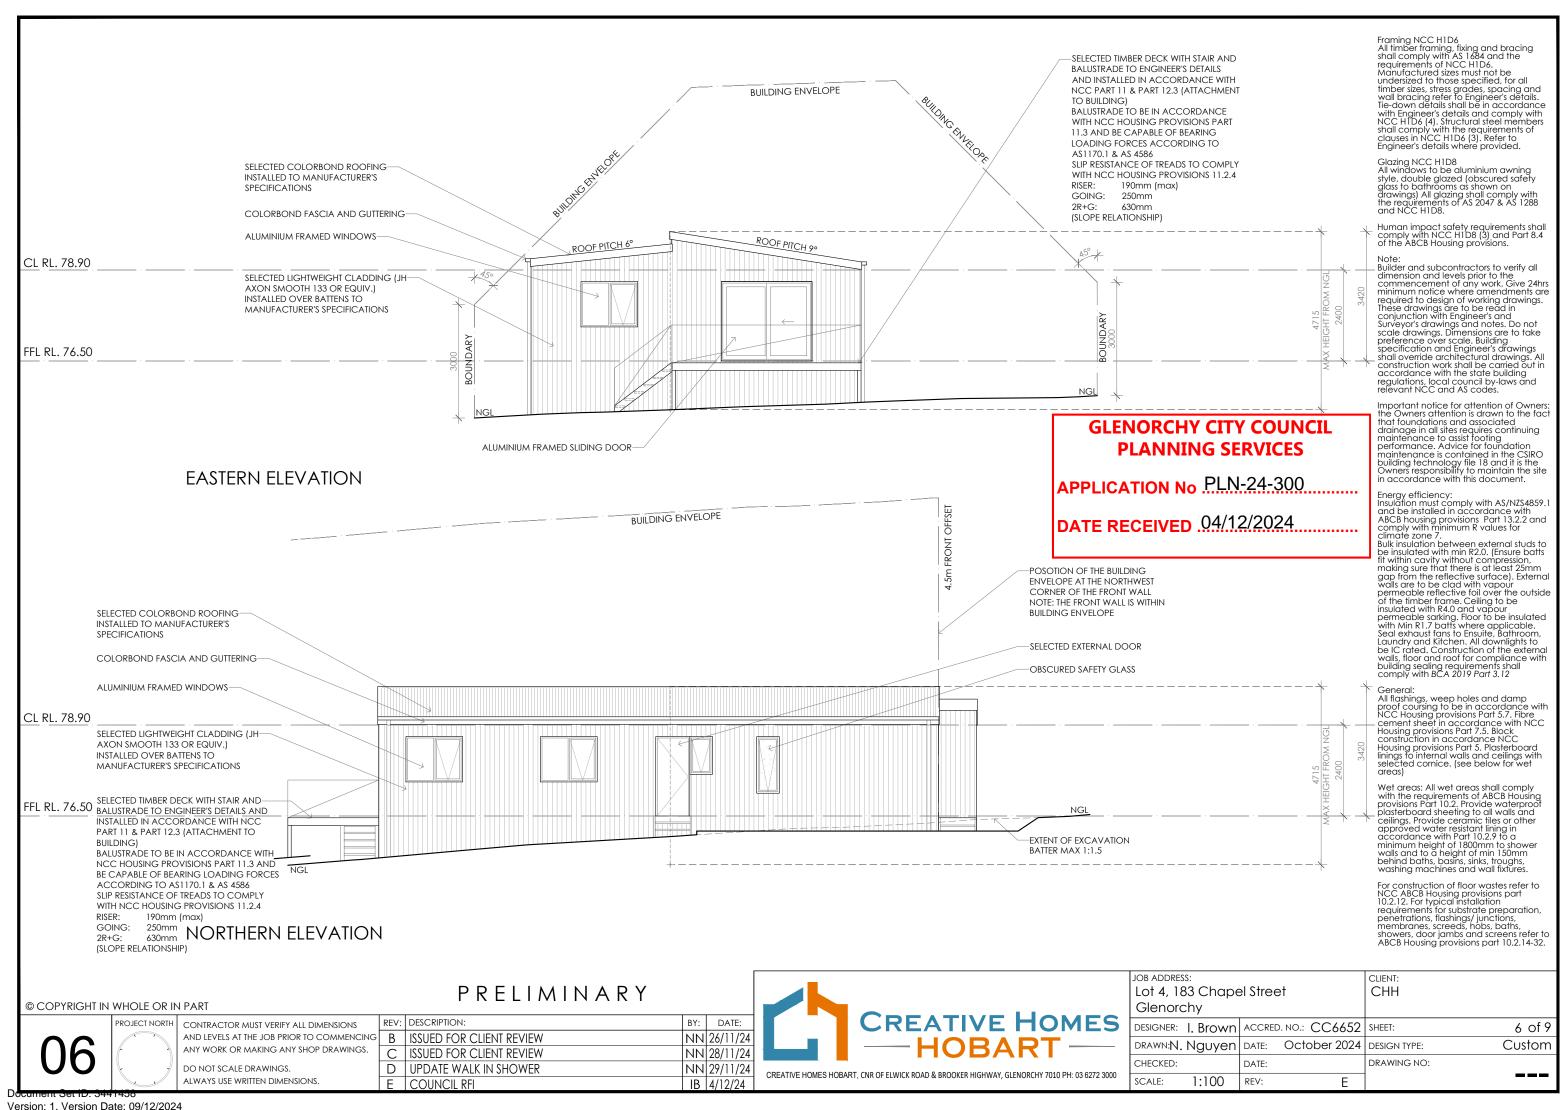

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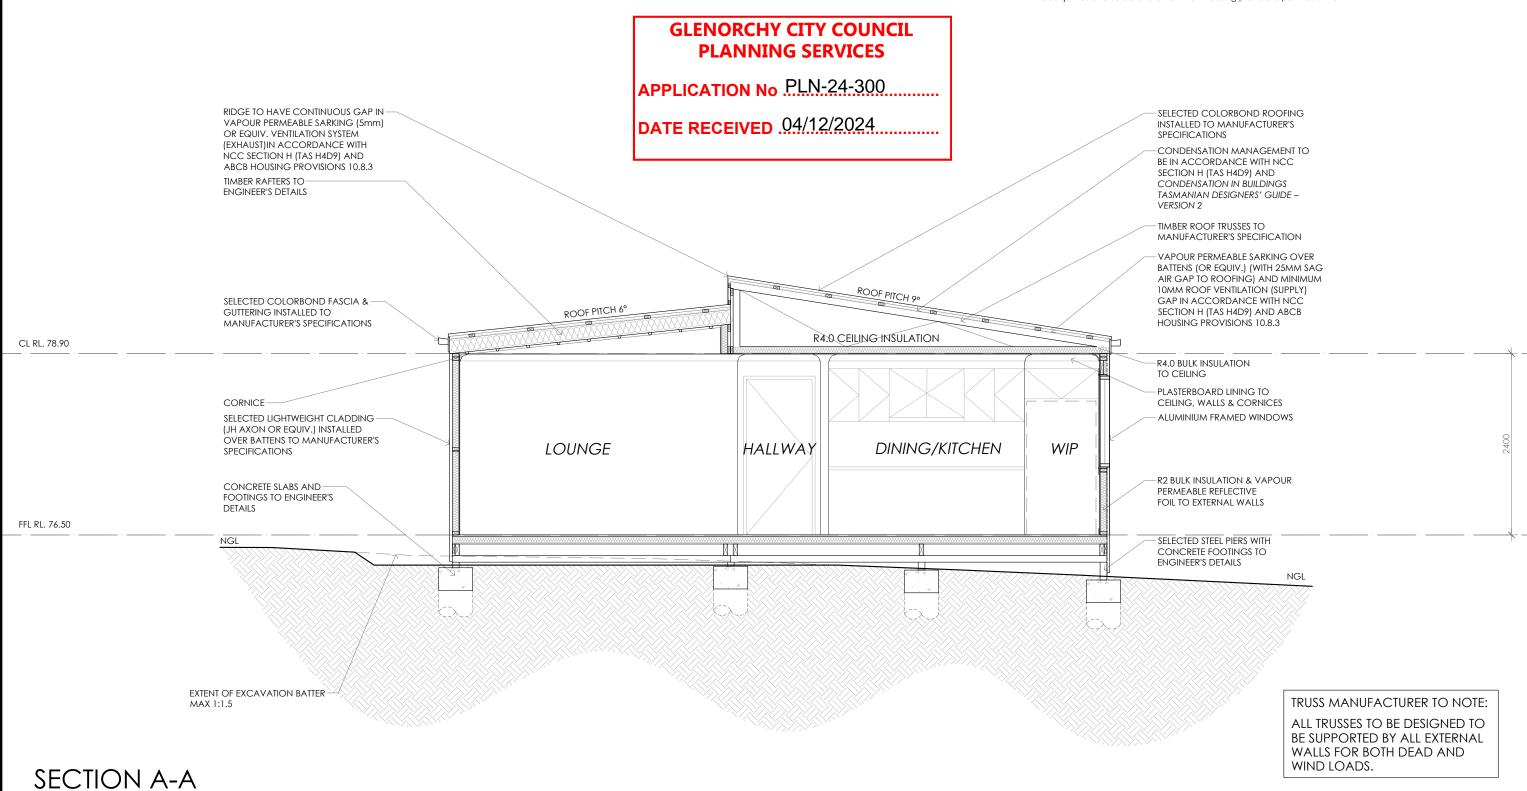
Energy efficiency:
Insulation must comply with AS/NZS4859.1 and be installed in accordance with ABCB housing provisions Part 13.2.2 and comply with minimum R values for climate zone 7.
Bulk insulation between external studs to be insulated with min R2.0. (Ensure batts fit within cavity without compression, making sure that there is at least 25mm gap from the reflective surface). External walls are to be clad with vapour permeable reflective foil over the outside of the timber frame. Ceiling to be insulated with R4.0 and

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PRELIMINARY



JOB ADDRESS: CLIENT: Lot 4, 183 Chapel Street CHH Glenorchy DESIGNER: I. Brown ACCRED. NO.: CC6652 SHEET: 7 of 9 October 2024 DESIGN TYPE: DRAWN:N. Nguyen | DATE: Custom DRAWING NO: CHECKED: DATE: SCALE: 1:50 REV: Е

