

DEVELOPMENT APPLICATION

APPLICATION NUMBER: PLN-24-245

PROPOSED DEVELOPMENT: Multiple Dwellings (4 new)

LOCATION: 38 Maroubra Circle Chigwell

APPLICANT: Homes Tasmania (Hobart)

ADVERTISING START DATE: 15/01/2025

ADVERTISING EXPIRY DATE: 29/01/2025

Plans and documentation are available for inspection at Council's Offices, located at 374 Main Road, Glenorchy between 8.30 am and 5.00 pm, Monday to Friday (excluding public holidays) and the plans are available on Glenorchy City Council's website (www.gcc.tas.gov.au) until 29/01/2025.

During this time, any person may make representations relating to the applications by letter addressed to the Chief Executive Officer, Glenorchy City Council, PO Box 103, Glenorchy 7010 or by email to gccmail@gcc.tas.gov.au.

Representations must be received by no later than 11.59 pm on **29/01/2025**, or for postal and hand delivered representations, by 5.00 pm on **29/01/2025**.

ABN 19 753 252 493

Multiple Dwellings

PROJECT SPECIFIC:

Homes Tasmaina 38 Maroubra Circle

CHIGWELL

Tasmanian Planning Scheme Title Reference: Vol 64912 / Folio 40

NCC DEEMED TO SATISFY Mr Marcus Ralph CC1317F Climate Zone 7

Layout	ID	Drawing Name	Last Updated	Scale
997-01 Cover Page	1 2	Sub Floor (4) Drawing List (6)	12/12/2024 9:32 1: 12/12/2024 9:32 1:	
997-02 Floor Plan	1	Sub Floor (64)	25/09/2024 1:04 1:	
997-03 Elevations unit 1	1	Sub Floor (65)	25/09/2024 1:04 1:	100
997-04 Elevations Unit 2	1	Sub Floor (65)	25/09/2024 1:04 1:	100
997-05 Elevations Unit 3	1	Sub Floor (65)	25/09/2024 1:04 1:	100
997-06 Elevations Unit 4	1	Sub Floor (65)	25/09/2024 1:04 1:	100
997-07 Long Section	1	Sub Floor (65)	25/09/2024 1:04 1:	100
997-08 Site Plan	1	Sub Floor (73)	25/09/2024 1:06 1:	200
997-10 Setbacks	1	Sub Floor (71)	12/12/2024 9:28 1:	200
997-11 Driveway Levels	1	Sub Floor (71)	12/12/2024 9:28 1:	200
997-12 Long Section	1	Sub Floor (71)	12/12/2024 9:30 1:	200
997-13 Driveway Levels	1	Sub Floor (78)	25/09/2024 1:04 1:	200
997-14 Drainage Plan	1	Sub Floor (78)	12/12/2024 9:30 1:	
997-15 Drainage Plan	1	Sub Floor (78)	12/12/2024 9:30 1:	
997-16 Landscaping plan	1	Sub Floor (78) Sub Floor (77)	12/12/2024 9:30 1: 25/09/2024 1:04 1:	
997-17 Landscaping Plan	1	Sub Floor (77)	12/12/2024 9:30 1:	
997-18 Sunshade Diagrams	1	Sub Floor (80)	12/12/2024 9:30 1:	
997-19 Sunshade Diagrams	1	Sub Floor (80)	12/12/2024 9:31 1:	
997-20 Turning Templates	1	Sub Floor (84)	12/12/2024 9:31 1:	200
997-21 Turning Templates	1	Sub Floor (84)	12/12/2024 9:31 1:	200
997-22 Turning Templates	1	Sub Floor (84)	12/12/2024 9:31 1:	200

SITE INFORMATION

Lot: 40

Title: 64912 folio 40 Land Size: 720.80 sqm

Council: Glenorchy Council Zoning: 8.0General Residential

Overlays:

D.A APPROVAL:REQUIRED

BAL:

WIND CLASSISIFCATION:

CLIMATE ZONE: 7 ENERGY RATING :Na

BUILDING CLASSISIFCATION: tba

Calculations

Calculations	
Unit 1 floor area Site Coverage unit 1 Unit 2 floor area Site Coverage Unit 2 Unit 3 floor area Site Coverage unit 3 Unit 4 floor area Site Coverage Unit 4	40.0 sqm 62.80sqm 40.0 sqm 62.80sqm 40.0 sqm 62.80sqm 40.0 sqm 62.80sqm
Concrete Driveway Site Area	309.00 sqm 720.80 sqm
site coverage Site Coverage	251.00 sqm 34.80%



LOCATION PLAN





IOT SCALE DRAWINGS.

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ISSUE DRAWING A01

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PROJECT NAME: Multiple Dwellings		
CLIENT:		
Homes Tasmaina		
38 Maroubra Circle	CHIGWELL	
	Date: 12/12/2024	DR

Cover Page

DRAWING NO.

997-01

PROJECT NO.

2024-997

SCALE: 1:100, 1:1.22

▼LEGEND

smoke detector hard wired to electrical system extractor fan with heating elements optional

∘DP

OAJ articulation joint

METER BOX meter box

LEGEND:

dw - dishwasher hp - hot plates ubo - under bench oven wo - wall oven bank sink - stainless kitchen sink sh - shower bth - bath wc - toilet

spa - spa bath vb -vanity basin tr - laundry trough wm - washing machine mh - manhole

820 door

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PM-09.41GR-01

Floor area 40.00 Sqm

Unit 1 floor area

Unit 2 floor area

Unit 3 floor area

Unit 4 floor area

Site Coverage unit 1

Site Coverage Unit 2

Site Coverage unit 3

Site Coverage Unit 4

Concrete Driveway

Cito Aron

Carport 22.80 Sqm

40.0 sqm

62.80sqm

40.0 sqm

62.80sqm

40.0 sqm

62.80sqm

40.0 sqm

62.80sqm

309.00 sgm

720 20 cam

1 Bed


☐ds or shs-structural support


UNIT 1 ffl 28.00 UNIT 2 ffl 27.70

> ffl 27.40 UNIT 4 ffl 27.20


UNIT 3

elevation 3,000

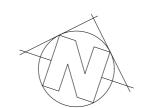


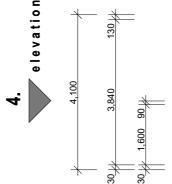



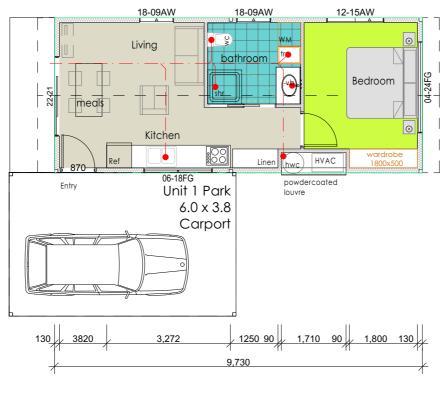



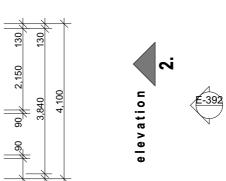



GLENORCHY CITY COUNCIL PLANNING SERVICES PLN-24-245 DATE RECEIVED 12 December 2024

FINISHES TAG **DESCRIPTION**

RS

Profile: Trimdek

Colour: as selected by owner.

Metal roof sheet (Colorbond)

Fixing method: crest fixing with roofzips M6-

11x65 (or equal)

FCS Fibre Cement sheet (James Hardie)

Profile: Axon (Vertical)

Paint Colour: as selected by owner.

Fixing method: To manufacturers specs

Spotted Gum bushfire resistant Decking & Landings:

timber, BAL 29 compliant

Bushfire resistant Timber Stairs:

Non-combustible material

SCALE: 1:100

6mm Fibre Cement sheet (James **Under Cladding:**

Fixing method: To manufacturers

specs

FINISHES

TAG DESCRIPTION M² Totals 45.35m² VT VINYL TILE CAR 16.6m² CARPET TIM TIMBER DECKING 2.8m²

Legend

DESCRIPTION TAG Pantry Fridge HP Heat Pump HWC Hot Water Cylinder



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ISSUE DRAWING A01

Floor Plan Multiple Dwellings PROJECT NO. DRAWING NO. Homes Tasmaina 2024-997 997-02 **CHIGWELL** 38 Maroubra Circle

Date: 12/12/2024




North West Elevation

PM-09.41GR-01

1 Bed

SCALE 1:100

ELEVATION 04 South West Elevation PM-09.41GR-01 1 Bed SCALE 1:100

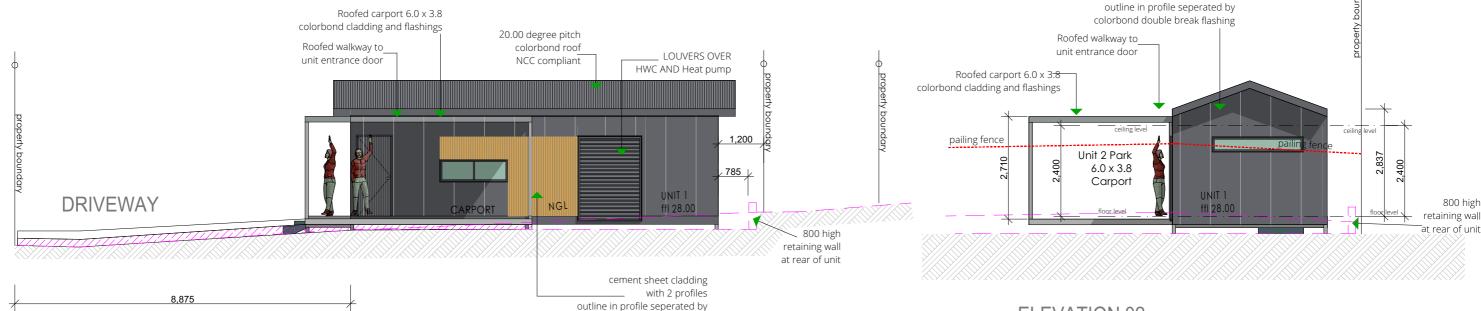

ELEVATION 01 South Eest Elevation PM-09.41GR-01 1 Bed SCALE 1:100

ELEVATION 02 North East Elevation PM-09.41GR-01 1 Bed



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colorbond double break flashing

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ISSUE DRAWING A01

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Multiple Dwellings			Elevations u	nit 1
CLIENT :			PROJECT NO.	DRAWING NO.
Homes Tasmaina			PROJECT NO.	DRAWING NO.
			2024-997	997-03
SITE:	CHIGWELL		2024-997	997-03
38 Maroubra Circle	CHIGWLLL			
	Date: 12/12/2024	DRAWN BY :Marcus	SCALE : 1·100	

SCALE: 1:100

cement sheet cladding with 2 profiles



South Eest Elevation
PM-09.41GR-01
1 Bed

North East Elevation
PM-09.41GR-01
1 Bed

SCALE 1:100



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colorbond double break flashing


ISSUE DRAWING A01

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PROJECT NAME :		Flanctions II	! 4 0
Multiple Dwellings		Elevations U	nit Z
CLIENT:		PROJECT NO.	DRAWING NO.
Homes Tasmaina		PROJECT NO.	DRAWING NO.
		2024-997	997-04
38 Maroubra Circle	CHIGWELL	2024-997	337 - 04


SCALE: 1:100

Date: 12/12/2024

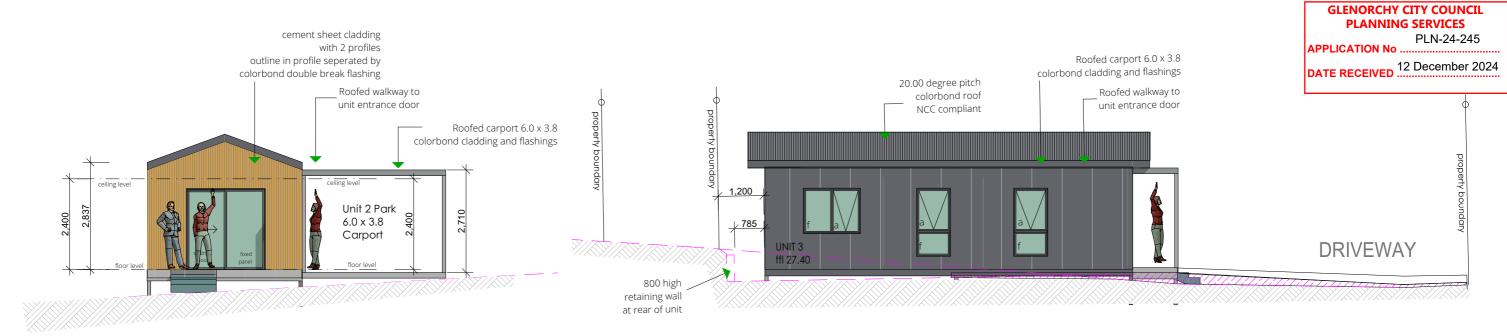

ELEVATION 04
South West Elevation
PM-09.41GR-01
1 Bed
SCALE 1:100

North West Elevation
PM-09.41GR-01
1 Bed

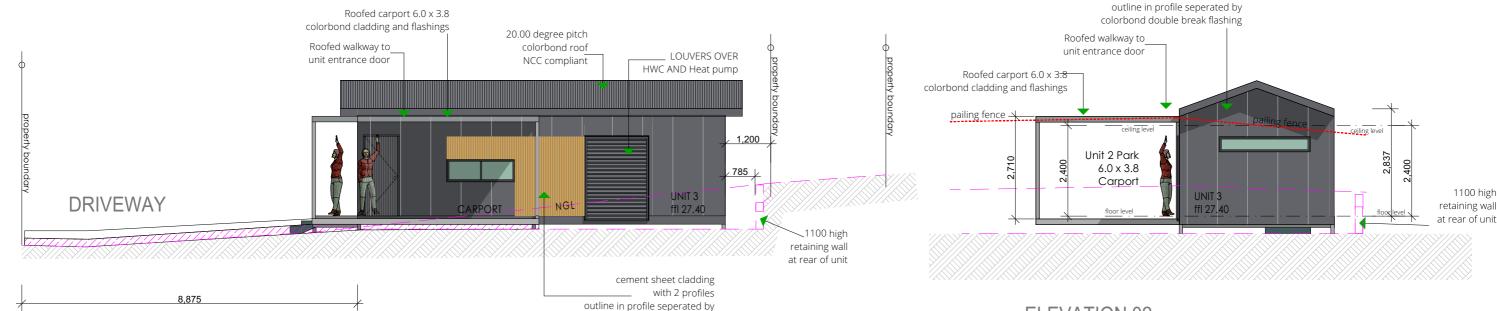

ELEVATION 01
South Eest Elevation
PM-09.41GR-01
1 Bed
SCALE 1:100

ELEVATION 02
North East Elevation
PM-09.41GR-01
1 Bed
SCALE 1:100



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colorbond double break flashing

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ISSUE DRAWING A01

PROJECT NAME :		F1(!	!4.0
Multiple Dwellings		Elevations U	nit 3
CLIENT:		PROJECT NO.	DRAWING NO.
Homes Tasmaina		PROJECT NO.	DRAWING NO.
		2024-997	997-05
38 Maroubra Circle	CHIGWELL	2024-997	997-03

SCALE: 1:100

Date: 12/12/2024

cement sheet cladding with 2 profiles



South West Elevation PM-09.41GR-01 1 Bed

SCALE 1:100

Roofed carport 6.0 x 3.8 colorbond cladding and flashings 20.00 degree pitch Roofed walkway to colorbond roof LOUVERS OVER unit entrance door NCC compliant HWC AND Heat pump 1,200 / 785 J UNIT 4 **DRIVEWAY** ffl 27.20 1100 high retaining wall at rear of unit cement sheet cladding with 2 profiles outline in profile seperated by colorbond double break flashing

North West Elevation PM-09.41GR-01 1 Bed SCALE 1.100

cement sheet cladding with 2 profiles outline in profiles seperated by colorbond double break flashing Roofed walkway to unit entrance door

Roofed carport 6.0 x 3.8

colorbond cladding and flashings

pailing fence

Unit 2 Park
6.0 x 3.8
Carport

UNIT 4

floor level

Indicate level

In

ELEVATION 01
South Eest Elevation
PM-09.41GR-01
1 Bed
SCALE 1:100

ELEVATION 02
North East Elevation
PM-09.41GR-01
1 Bed
SCALE 1:100



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ISSUE DRAWING A01

PROJECT NAME :			Flavationa II	!1 /
Multiple Dwellings			Elevations U	nit 4
CLIENT :			PROJECT NO.	DRAWING NO.
Homes Tasmaina			PROJECT NO.	DRAWING NO.
			2024-997	997-06
38 Maroubra Circle	CHIGWELL		2024-337	337-00
	Date: 12/12/2024	DRAWN BY :Marcus Ralph	SCALE : 1:100	



ELEVATION 04 South West Elevation PM-09.41GR-01 1 Bed

ELEVATION 04 South West Elevation PM-09.41GR-01 1 Bed

Long Section through site



DESIGN APPROVAL


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ISSUE DRAWING A01 Campania 09.41

PROJECT NAME: Multiple Dwellings			Long Section	1
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38 Maroubra Circle	CHIGWELL		2024-997	997-07
	Date: 12/12/2024	DRAWN BY :Marcus	SCALE : 1·100	

SCALE: 1:100



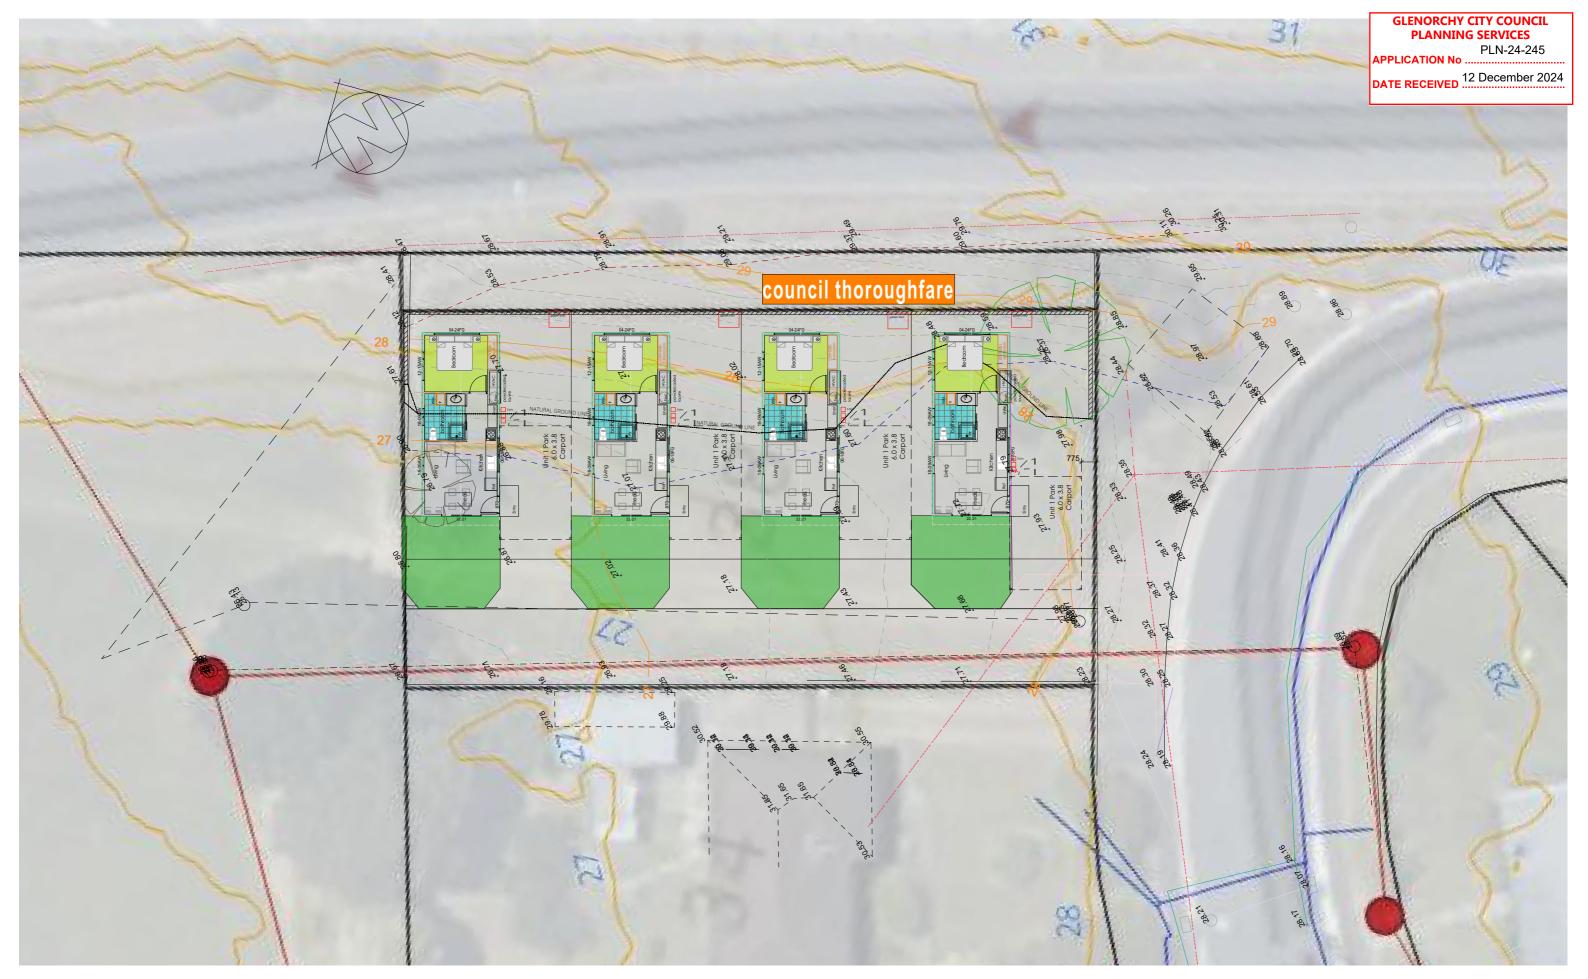

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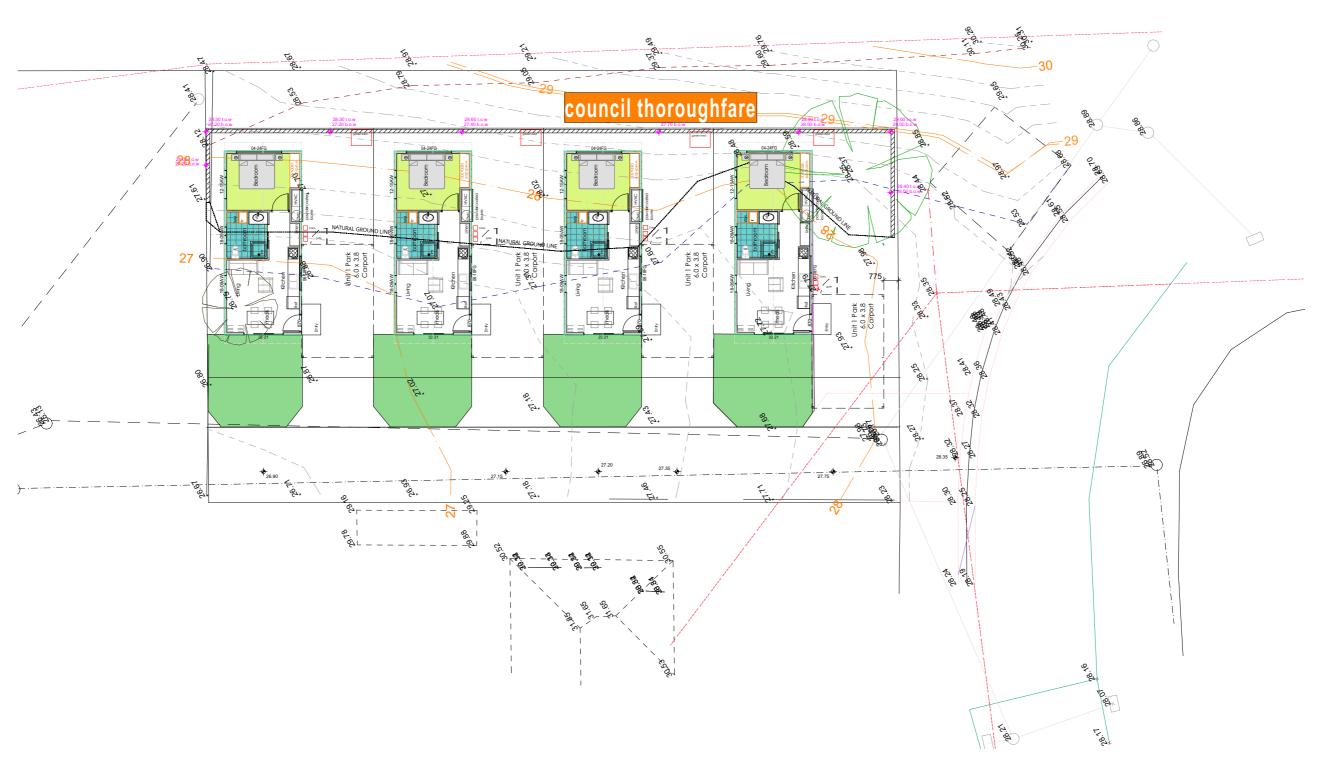
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ISSUE DRAWING A01

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Multiple Dwellings			Site Plan	
CLIENT :			PROJECT NO.	DRAWING NO.
Homes Tasmaina			PROJECT NO.	DRAWING NO.
			2024-997	997-08
38 Maroubra Circle	CHIGWELL		2024-337	<i>JJ1</i> -00
	Date: 12/12/2024	DRAWN BY :Marcus Ralph	SCALE : 1:200	

DATE RECEIVED 12 December 2024







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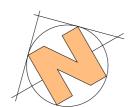
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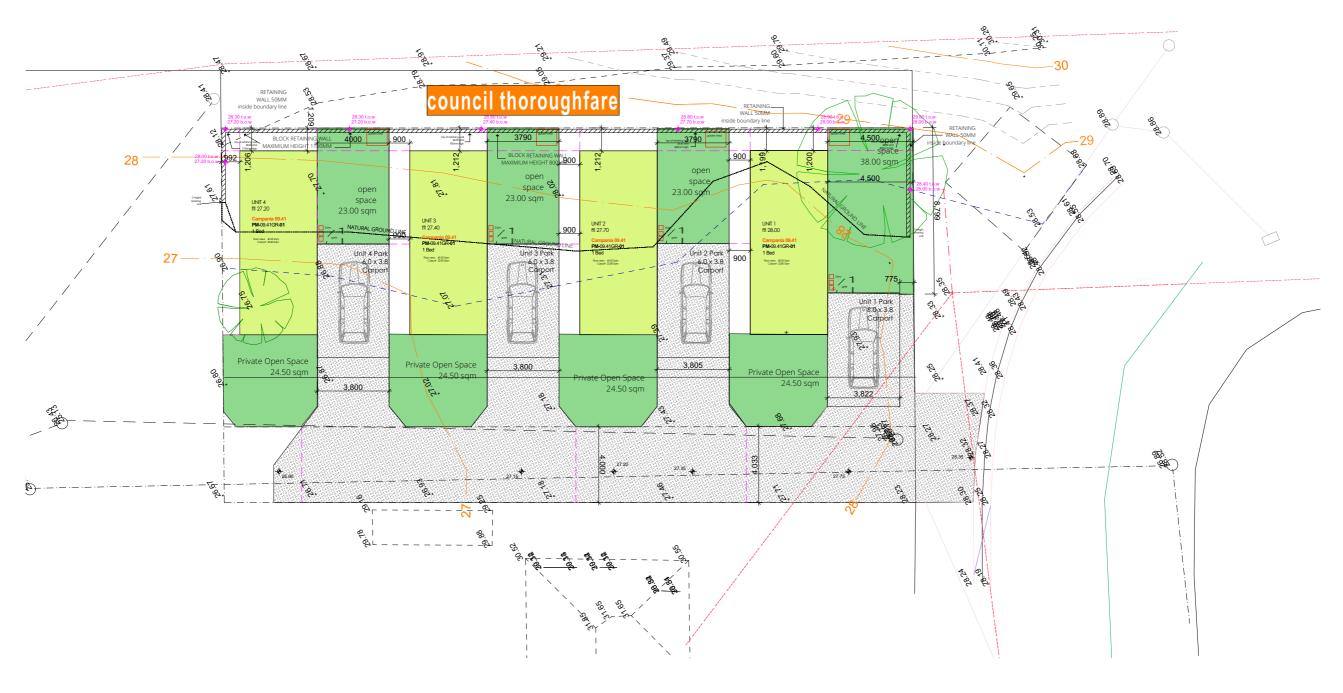
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ISSUE DRAWING A01

PROJECT NAME :			I	
Multiple Dwellings			Site Plan	
Homes Tasmaina			PROJECT NO.	DRAWING NO.
38 Maroubra Circle	CHIGWELL		2024-997	997-09
	Date: 12/12/2024	DRAWN BY :Marcus Ralph	SCALE : 1:200	

DATE RECEIVED 12 December 2024







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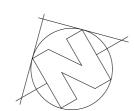
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ISSUE DRAWING A01

PROJECT NAME :			0.46	
Multiple Dwellings			Setbacks	
CLIENT :			PROJECT NO.	DRAWING NO.
Homes Tasmaina			PROJECT NO.	DRAWING NO.
			2024-997	997-10
sme: 38 Maroubra Circle	CHIGWELL		2024-997	337-10
00 Maroobia Circic				
	Date: 12/12/2024	DRAWN BY :Marcus Ralph	SCALE : 1:200	

GLENORCHY CITY COUNCIL PLANNING SERVICES PLN-24-245

DATE RECEIVED 12 December 2024







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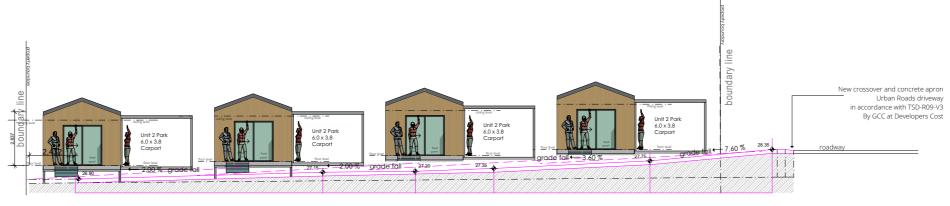
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revision-date
ISSUE DRAWING A01


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Multiple Dwellings			Driveway Lev	VE15
CLIENT :			PROJECT NO.	DRAWING NO.
Homes Tasmaina			PROJECT NO.	DRAWING NO.
SITE:			2024-997	997-11
38 Maroubra Circle	CHIGWELL		2024 337	227 11
	Date: 12/12/2024	DRAWN BY :Marcus Ralph	SCALE : 1:200	

SCALE: 1:200



Design Drawing driveway levels

ELEVATION 04 South West Elevation PM-09.41GR-01 1 Bed

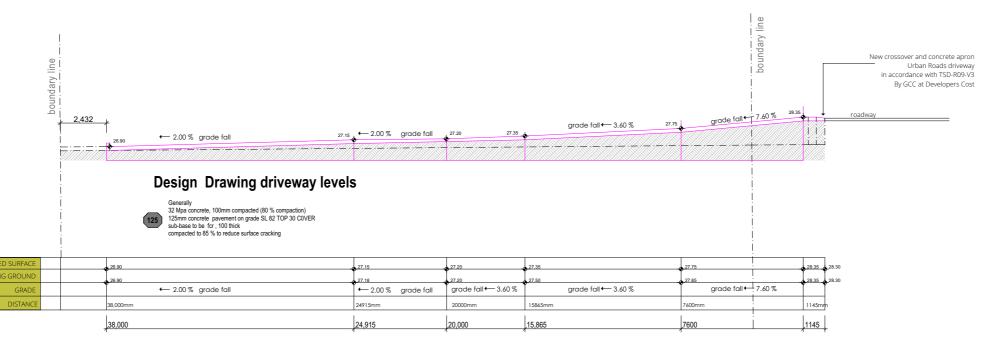

Longitudinal Section through driveway

DOWN CENTRELINE



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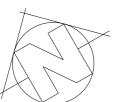
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ISSUE DRAWING A01

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PROJECT NAME : Multiple Dwellings			Long Section	1
Homes Tasmaina			PROJECT NO.	DRAWING NO
site: 38 Maroubra Circle	CHIGWELL		2024-997	997-12
	Date: 12/12/2024	DRAWN BY :Marcus	SCALE : 1:200	


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GLENORCHY CITY COUNCIL PLANNING SERVICES PLN-24-245

APPLICATION No

DATE RECEIVED 12 December 2024



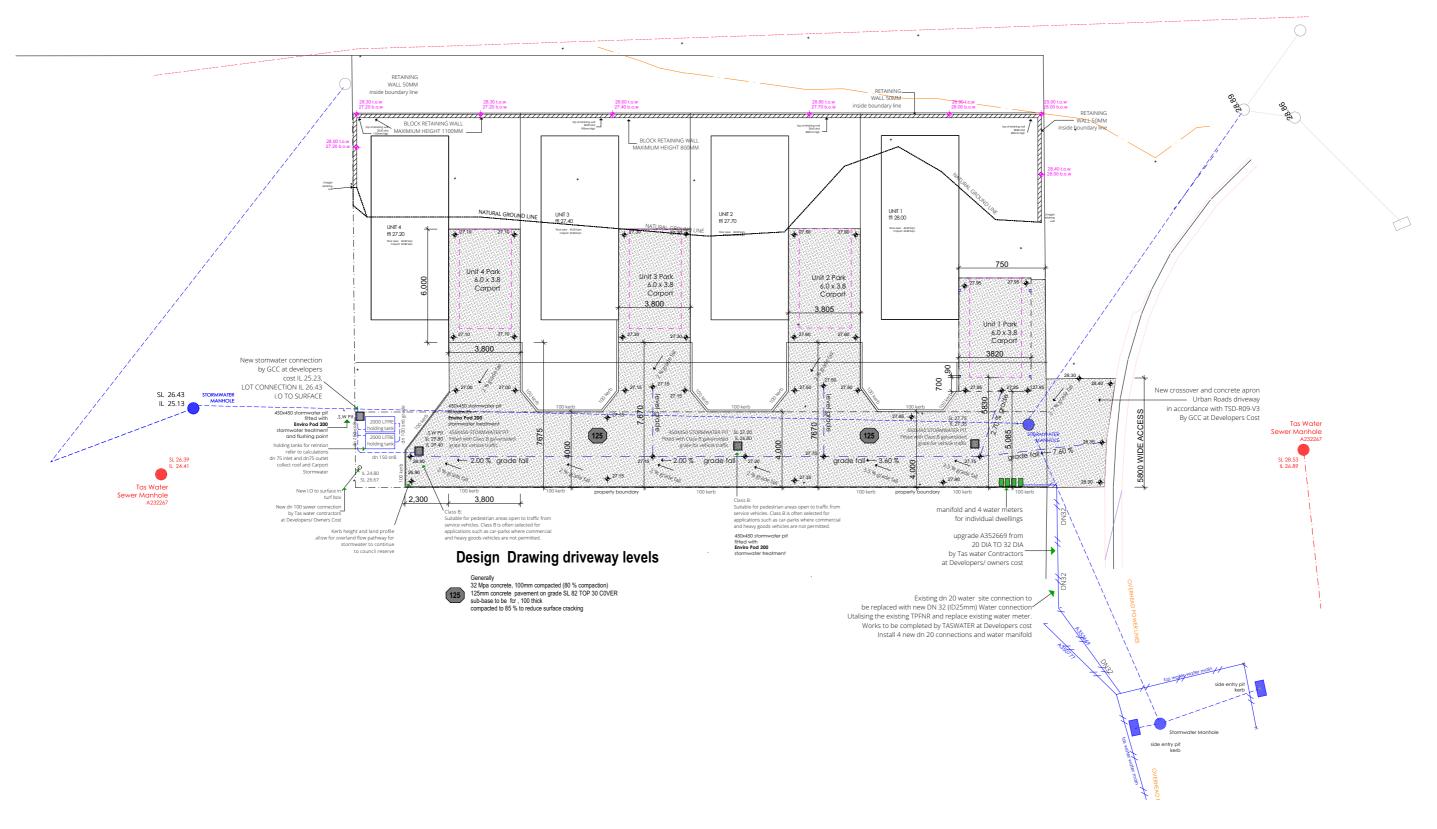

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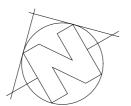
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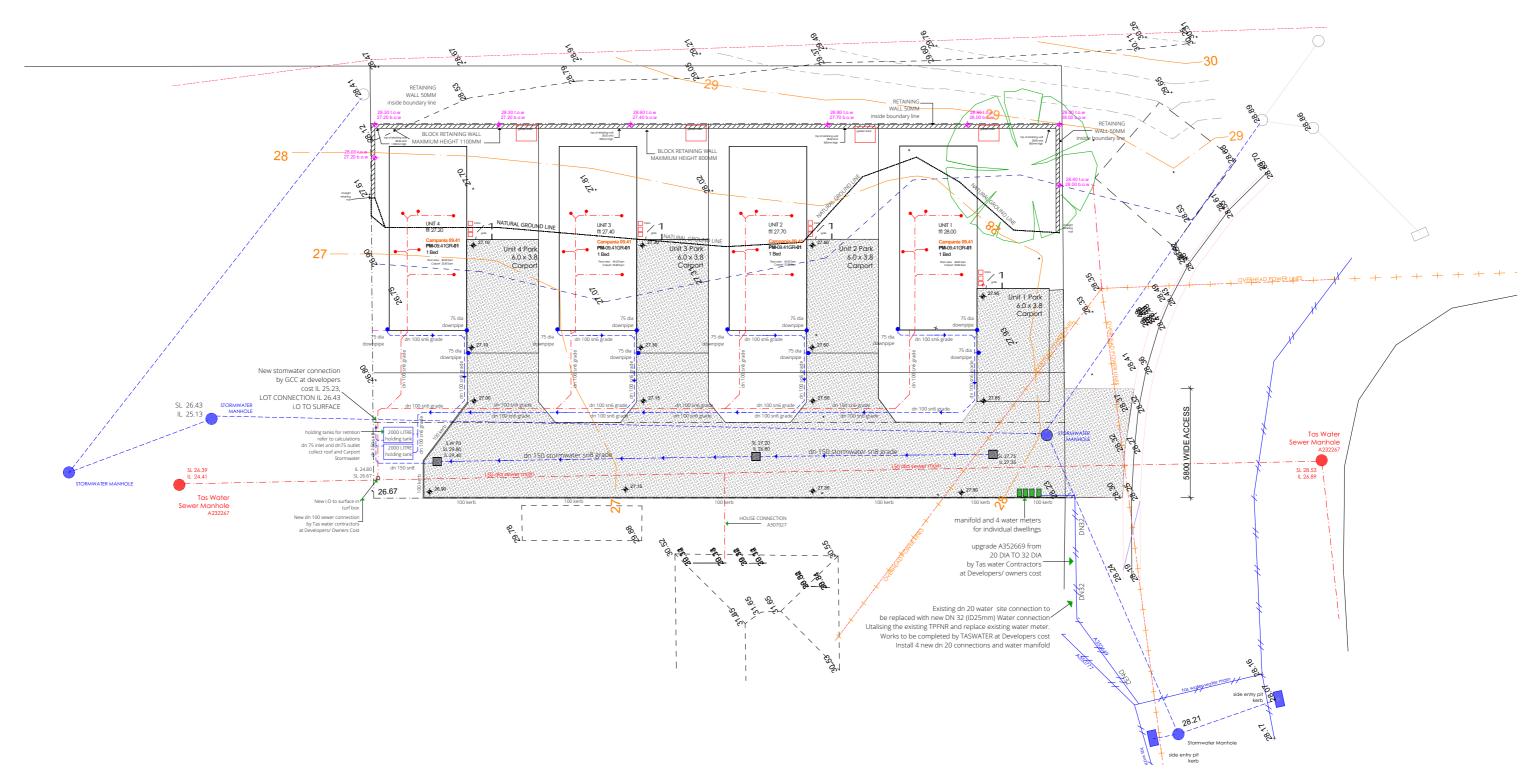
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ISSUE DRAWING A01

PROJECT NAME: Multiple Dwellings			Driveway Le	vels
Homes Tasmaina			PROJECT NO.	DRAWING NO.
38 Maroubra Circle	CHIGWELL		2024-997	997-13
	Date: 12/12/2024	DRAWN BY : Marcus	SCALE : 1-200	







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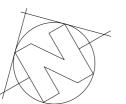
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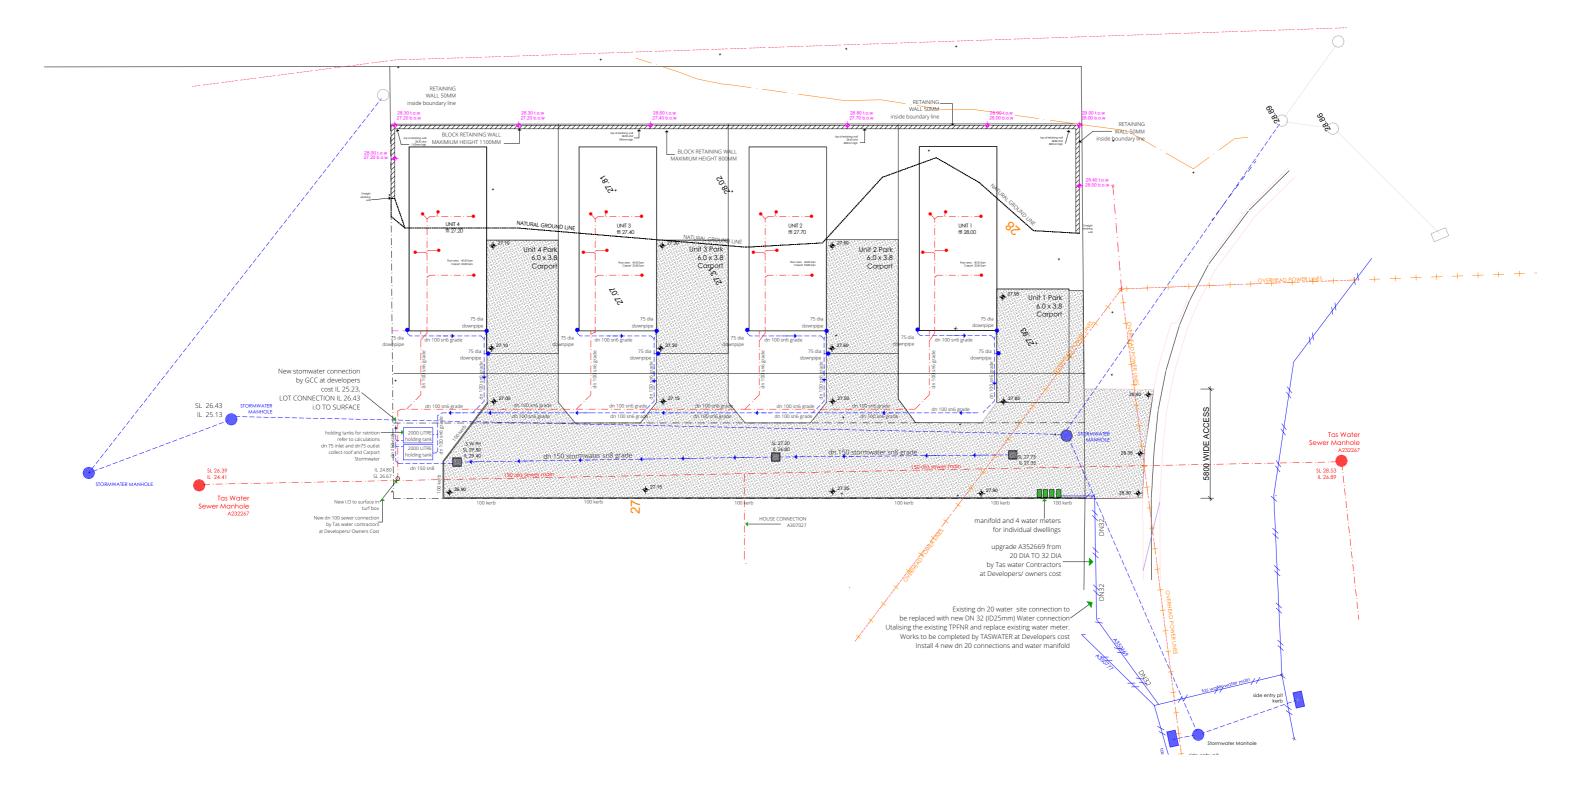
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DESIGN APPROVAL

revision-date
ISSUE DRAWING A01

PROJECT NAME :			D.,.!	
Multiple Dwellings			Drainage Pla	n
CLIENT :			PROJECT NO.	DRAWING NO.
Homes Tasmaina			i Roseer No.	Diaminio ito.
SITE:			2024-997	997-14
38 Maroubra Circle	CHIGWELL		202+ 337	337 11
	Date: 12/12/2024	DRAWN BY :Marcus Ralph	SCALE : 1:200	







SCALE DRAWINGS.

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ISSUE DRAWING A01

PROJECT NAME :			D!	
Multiple Dwellings			Drainage Pla	n
CLIENT :			PROJECT NO.	DRAWING NO.
Homes Tasmaina			PROJECT NO.	DRAWING NO.
			2024-997	997-15
38 Maroubra Circle	CHIGWELL		2024-337	JJ1-1J
	Date: 12/12/2024	DRAWN BY :Marcus Ralph	SCALE : 1:200	

APPLICATION No

DATE RECEIVED 12 December 2024

LANDSCAPING LEGEND:



PROPOSED BUILDING



GARDEN SHED



clothes line



100 thick reinforced concrete pathway





<u>TREES</u>

Tall tree or small tree



concrete driveway Refer to Engineers Drawings



LAWN AREA 100mm loam raked level and rolled compressed seeded with general fescue /rye seed.



Garden bed cultivated with dynamic lifter pelets topped with GUM MULCH 100MM THICK



Crushed rock garden bed with weed matting to a depth of 75mm.


20mm clean TASSIE GOLD




Crushed rock garden bed with weed matting to a depth of 75mm.

20mm clean White ICE ROCK



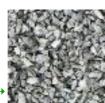

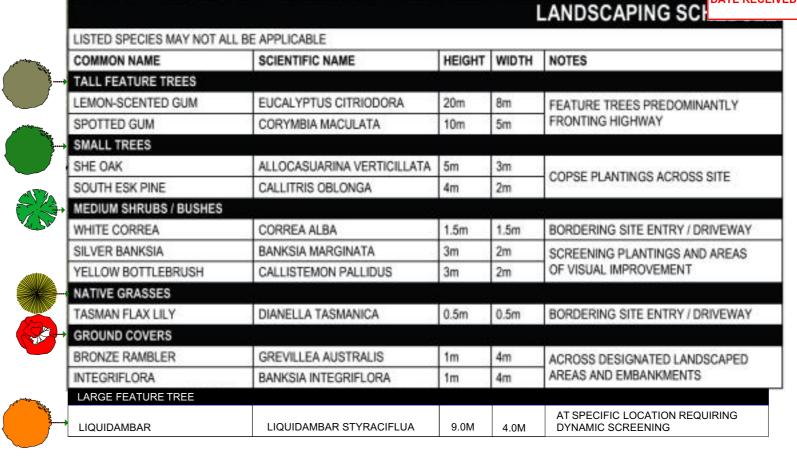







Banksia Intergriflora



emon Scented Gum



Gum





potted Gum





Yellow Bottlebrush



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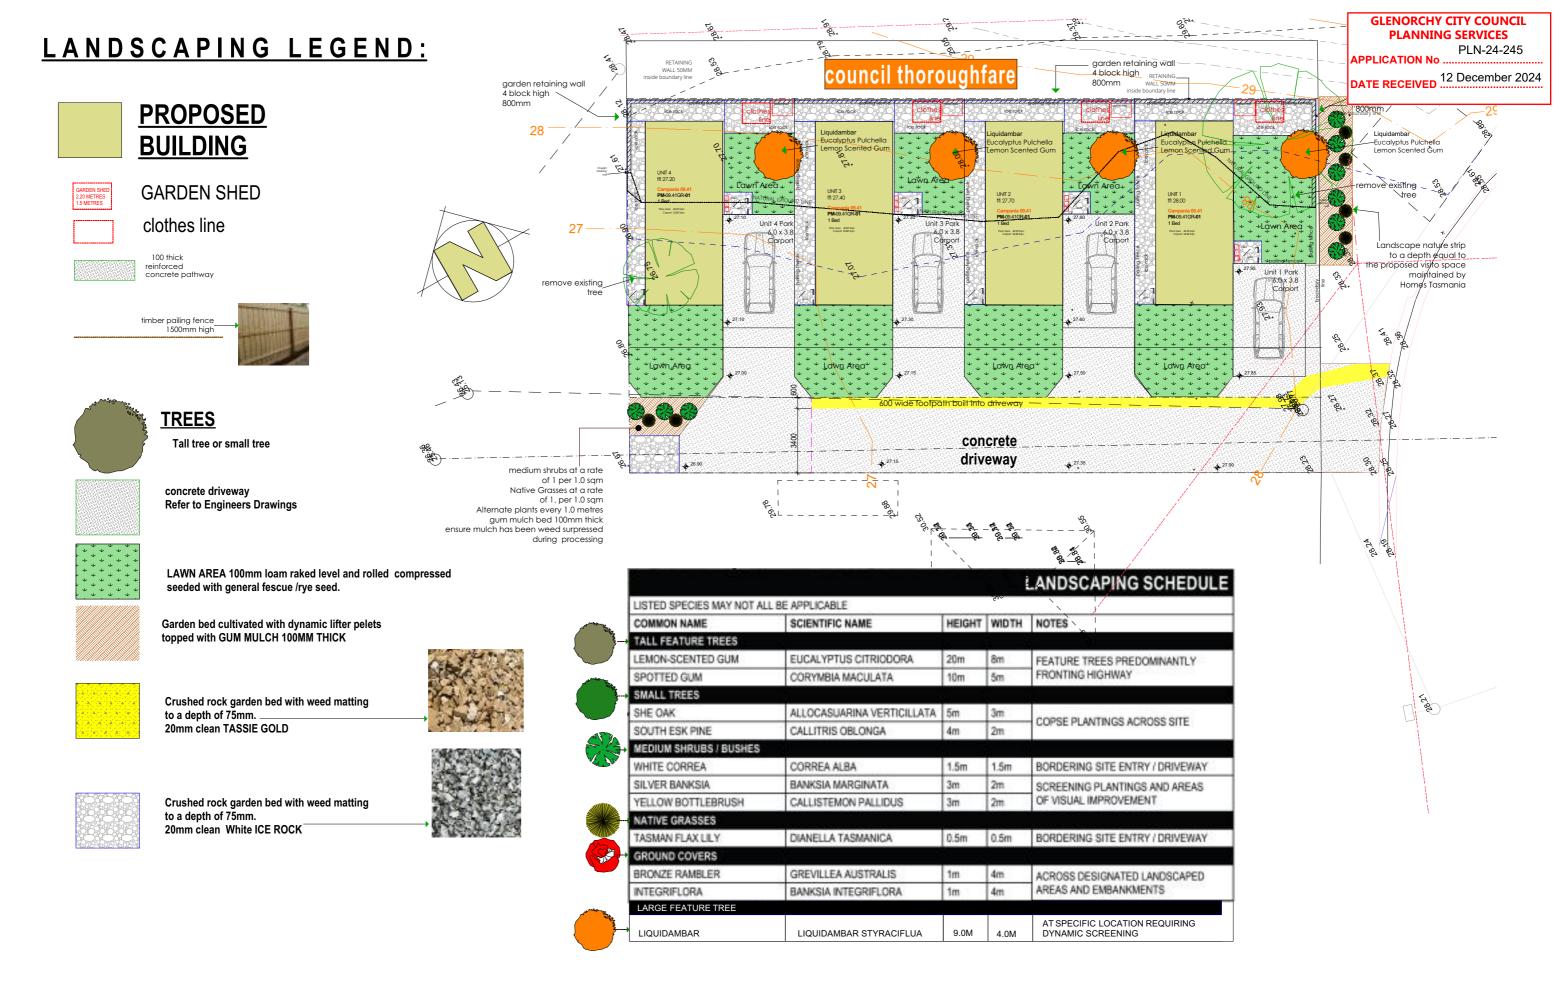
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ISSUE DRAWING A01

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Multiple Dwellings			Landscaping	j plan
Homes Tasmaina			PROJECT NO.	DRAWING NO.
38 Maroubra Circle	CHIGWELL		2024-997	997-16
	Date: 12/12/2024	DRAWN BY :Marcus	SCALE : 1:200	





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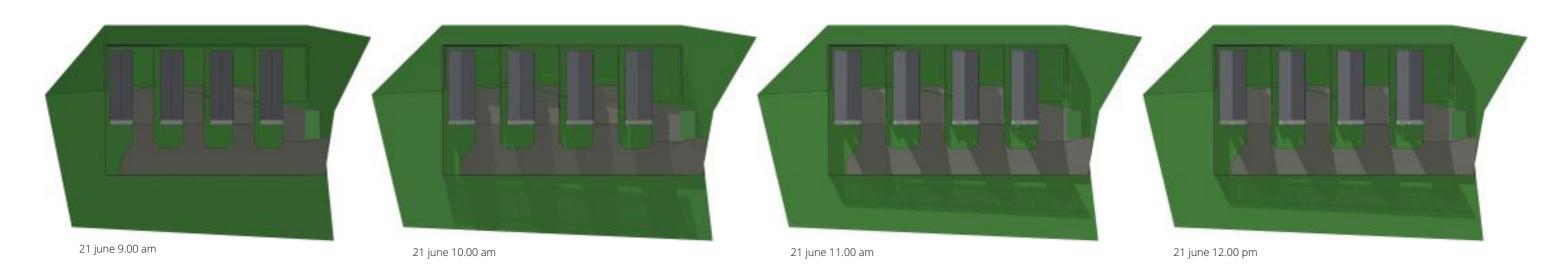
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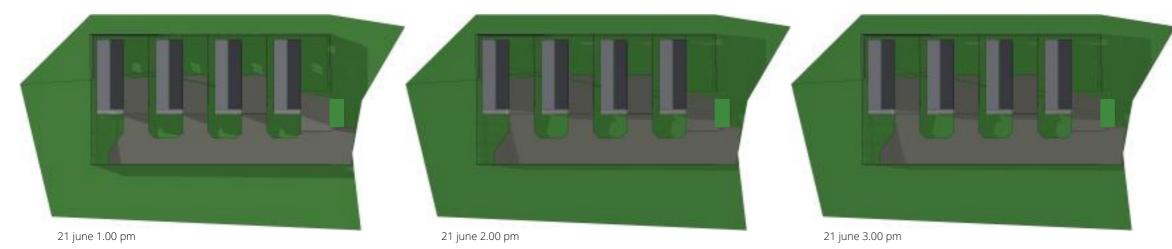
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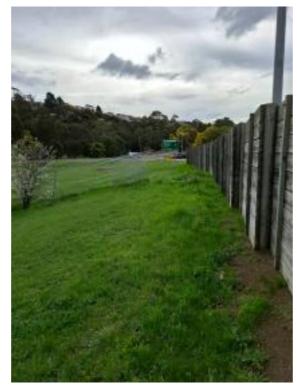
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site: 38 Maroubra Circle	CHIGWELL		2024-997	997-17
O Marobia Circio	Date: 12/12/2024	DRAWN BY :Marcus	SCALE : 1:200	





SUNSHADE DIAGRAMS 21 JUNE 9.00 AM TO 3.00 PM





public thoroughfare

site photo



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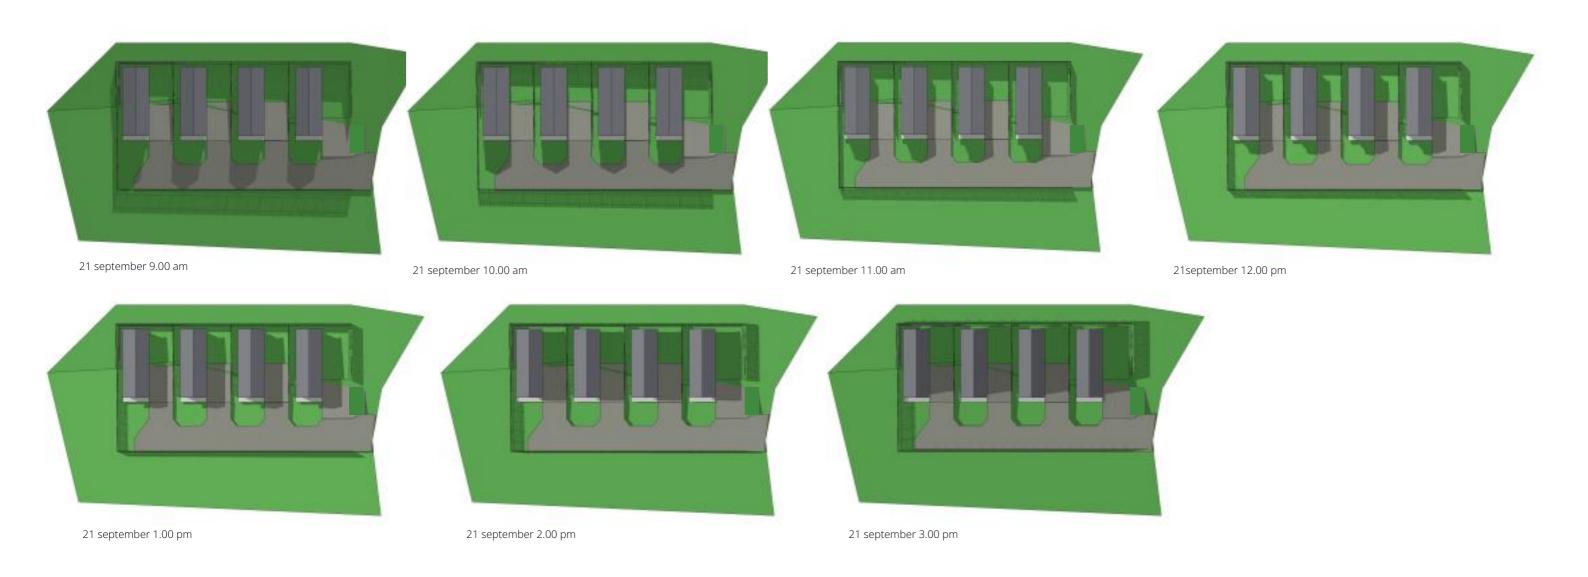
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SUNSHADE DIAGRAMS 21 SEPTEMBER 9.00 AM TO 3.00 PM



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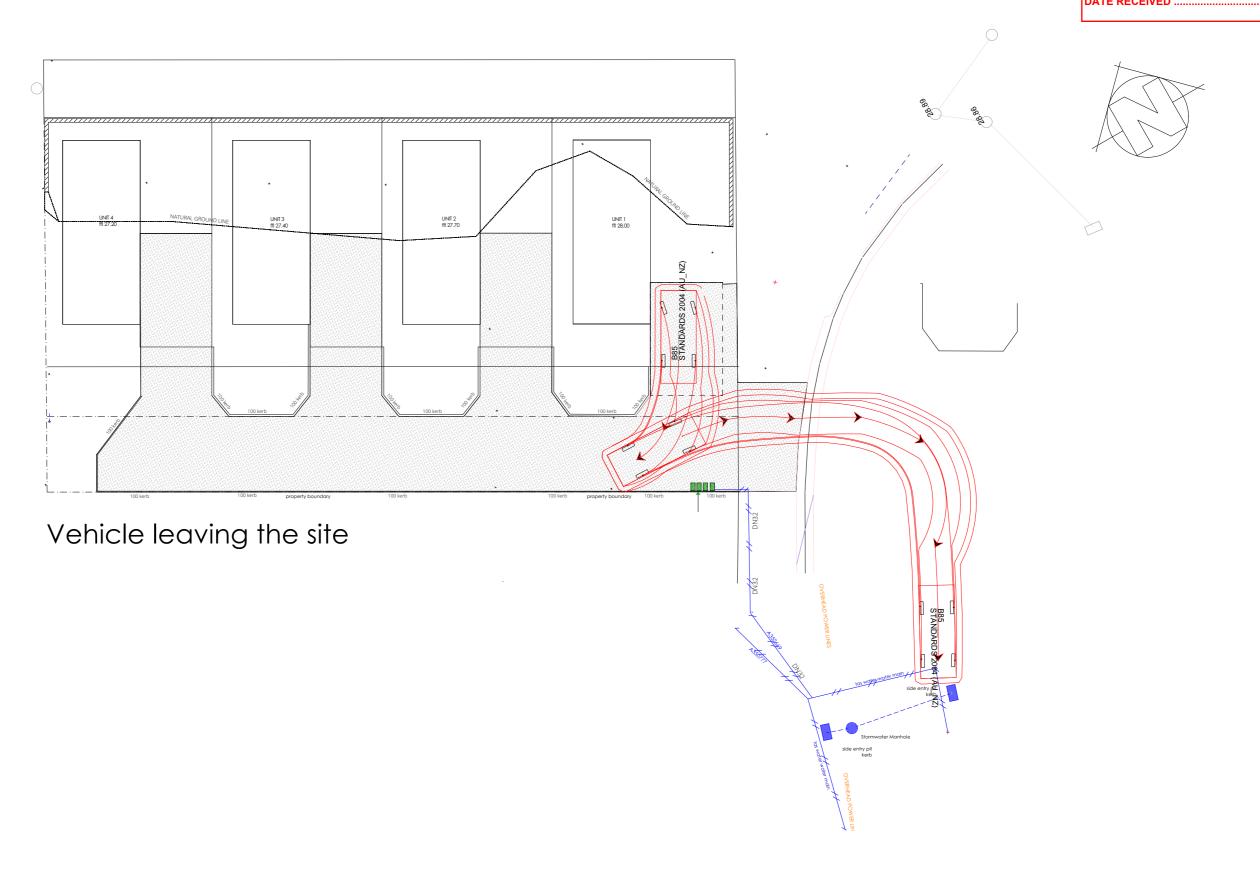
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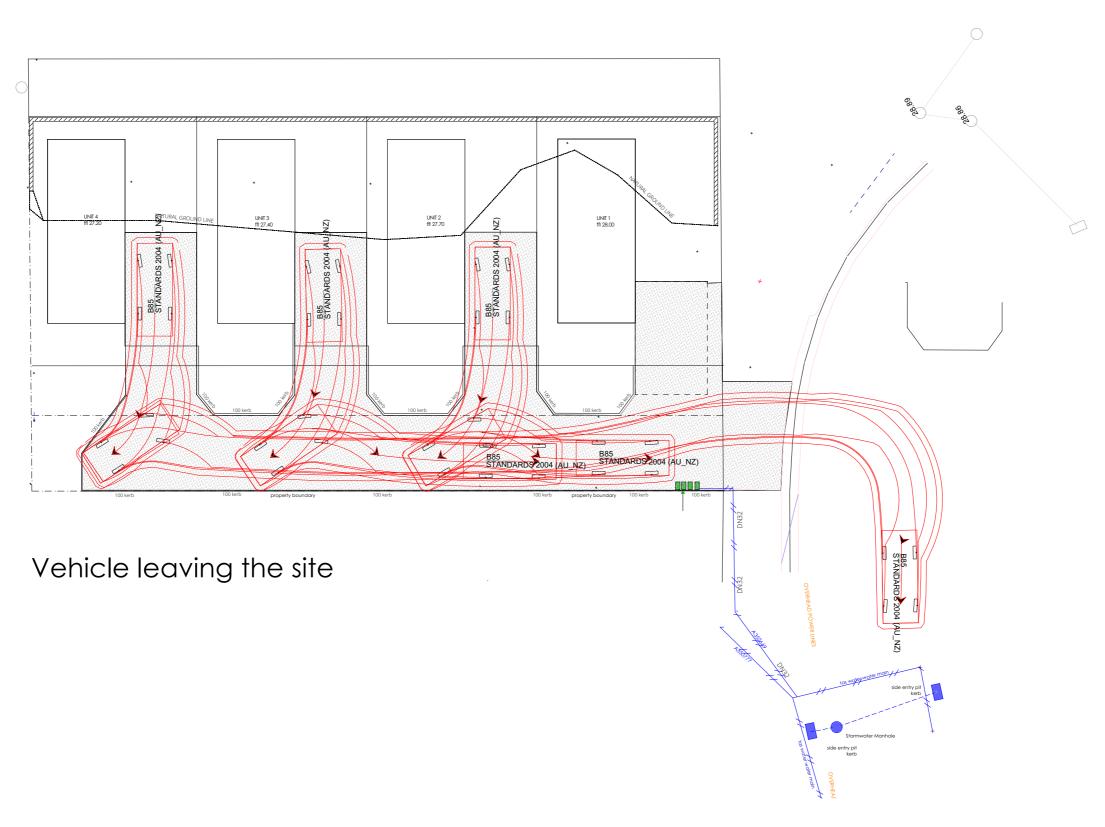
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GLENORCHY CITY COUNCIL PLANNING SERVICES PLN-24-245 DATE RECEIVED 12 December 2024





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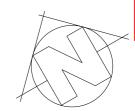
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GLENORCHY CITY COUNCIL PLANNING SERVICES PLN-24-245

DATE RECEIVED 12 December 2024







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	38 Maroubra Circle	CHIGWELL		

SCALE: 1:200

Date: 12/12/2024

GLENORCHY CITY COUNCIL PLANNING SERVICES

APPLICATION NoPLN-24-245

DATE RECEIVED 23 December 2024

Mon, 23 Dec 2024 11:20:47 +1100

Please find attached and below information pertaining to the RFI received 12 December 2024 covering off the first four dot points.

- 8.4.1 Connection will be undertaken as first stage of the development to move the public which currently utilise the site as designated connection. Approval has been gained from Glenorchy City Council Property Division to construct a gravel path on the adjacent council. This will be undertaken prior to any construction on site to move the public currently utilising the site as pedestrian connection. This could potentially covered off as a condition, as I have been advised by Luke Chiu that no planning approval is required Refer approval from Luke at base of this email.
- 8.4.2 -

Sent:

- Retaining wall within 4.5m of the road was a 200mm high garden wall. This has now been deleted with the ground being battered on a slope instead
- Dwellings and a retaining wall within 3.0m from a secondary frontage. Whilst the
 adjoining Council walkway land is titled 'Subdivision Road', I submit that the narrow
 width and prescribed footway use of the land exempts this from being
 classifieds secondary frontage, with no other buildings adjoining to create a streetscape
 to be consistent with
- 8.4.2 front street facing carport has been removed deletion discretion this will also satisfy the TasNetworks referral requirement.
- C3.6.1 Amended traffic report attached.

Unfortunately the Hydraulic engineers look unlikely to be able to satisfy the full extent of the 'General Manager's Consent for Interference with Public Stormwater Systems' this side of Christmas (report and drawings), and more than likely will be the second week in January.

Noting they have undertook preliminary investigation and have advised the sufficient retention
will be able to be provided on site to meet Section 14(1) of the *Urban Drainage Act 2013...* in
line with other similar previously completed designs. Requesting accordingly that this be
conditioned as part of the approvals permit.

Kind Regards

Document Set ID: 3456095 Version: 1, Version Date: 23/02/2025





Homes Tasmania GPO Box 65 Hobart, TAS 7001 18 December 2024

Ref: 1695-1 38 Maroubra Circle Noise Assessment_01

Attention: Richard Blackwell

38 MAROUBRA CIRCLE - NOISE ASSESSMENT

A residential development is proposed for construction on a currently vacant lot at 38 Maroubra Circle, Chigwell, adjacent to the Brooker Highway. As such, this development triggers the Road and Railway Assets Code, and thus requires a noise assessment to demonstrate likely compliance with the *Tasmanian Planning Scheme* (the Scheme). NVC conducted a noise assessment in February 2023 based on preliminary plans, which have since been revised. This document (_01) presents an updated noise assessment following a revision to the site plant, completed by NVC in December 2024.

1. BACKGROUND

1.1. Site and Surrounding Area

Figure 1.1, below, shows an overview of the site and surrounding area. The site (white outline in Figure 1.1) is located at 38 Maroubra Circle, Chigwell, within a General Residential Zone under the Scheme (red overlay). The site is bounded by Maroubra Circle to the south, residential lots to the west, Recreational Zone to the north (green overlay) and the Brooker Highway to the east within a Utilities Zone (yellow overlay).



FIGURE 1.1: SITE AND SURROUNDING AREA

NVC Pty Ltd ABN 18 650 760 348 0437 659 123 jack@nvc.com.au

Document Set ID: 3456695 Version: 1, Version Date: 23/02/2025



A slip (exit) lane is located between the site and the Brooker Highway, with an existing barrier 2m high between the slip lane and the site. This barrier is constructed of pine sleepers, nominally 50mm thick. The highway is elevated relative to the site, with an approximate relative height of 1.8m, i.e. 0.2m below the top of the barrier.

The Brooker Highway is a major thoroughfare linking Hobart to the northern suburbs and connects to the Midland Highway, and as a result, it experiences significant light and heavy vehicle traffic. This portion of the highway has a 100 km/h speed limit, with the slip lane experiencing lower vehicle speeds.

1.2. Proposed Development

The proposed development comprises the construction of 4 identical one-bedroom residential units, with the proposed site plan shown below in Figure 1.2.

The building's construction is proposed to be primarily fibre cement sheeting with some glazing on the north-west and south-eastern facades and a typical Colorbond roof. It is noted there is no glazing proposed on the facade directly facing the highway. As far as NVC is aware, glazing specifications have yet to be determined.

The rear of all four units is approximately 1.2 m from the north-east boundary, which comprises a thoroughfare between the site and the Brooker Highway road corridor. As such, the units are located approximately 18 m from the verge of the Brooker Highway.

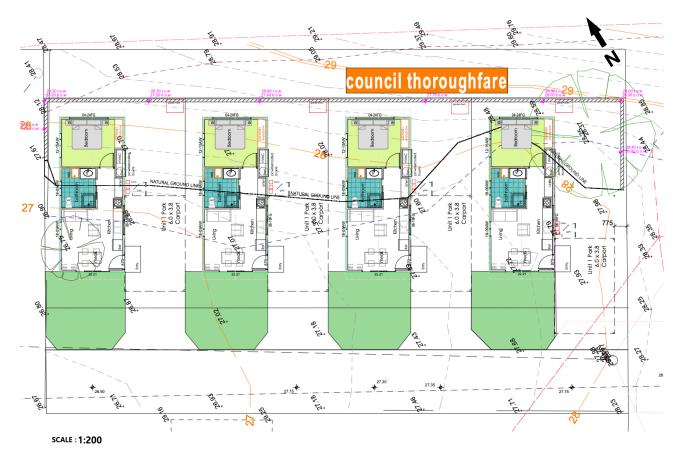


FIGURE 1.2: PROPOSED SITE PLAN



2. CRITERIA

Section C3.0 of the Tasmanian Planning Scheme (the Scheme) comprises the Road and Railway Assets Code. Specifically, clause C3.6.1 details requirements for Habitable buildings for sensitive uses within a road or railway attenuation area. This clause is reproduced below.

C3.6 Development Standards for Buildings or Works

C3.6.1 Habitable buildings for sensitive uses within a road or railway attenuation area

Objective:

To minimise the effects of noise, vibration, light and air emissions on sensitive uses within a road or railway attenuation area, from existing and future major roads and the rail network.

cceptable Solutions	Performance Criteria
1	P1
nless within a building area on a sealed plan approved or this planning scheme, habitable buildings for a ensitive use within a road or railway attenuation area, ust be:	Habitable buildings for sensitive uses within a road or railway attenuation area, must be sited, designed or screened to minimise adverse effects of noise, vibration, light and air emissions from the existing or future major road or rail network, having regard to:
 within a row of existing habitable buildings for sensitive uses and no closer to the existing or future major road or rail network than the adjoining habitable building; 	(a) the topography of the site;(b) the proposed setback;
o) an extension which extends no closer to the existing or future major road or rail network than:	(c) any buffers created by natural or other features;(d) the location of existing or proposed buildings on the
(i) the existing habitable building; or	site;
(ii) an adjoining habitable building for a sensitive use; or	(e) the frequency of use of the rail network;(f) the speed limit and traffic volume of the road;
o) located or designed so that external noise levels are not more than the level in Table C3.2 measured in accordance with Part D of the Noise Measurement Procedures Manual, 2nd edition, July 2008.	(g) any noise, vibration, light and air emissions from the rail network or road;
rroccadres riandal, 2nd caldon, saly 2000.	(h) the nature of the road;
	(i) the nature of the development;
	(j) the need for the development;
	(k) any traffic impact assessment;
	(I) any mitigating measures proposed;
	(m) any recommendations from a suitably qualified person for mitigation of noise; and
	(n) any advice received from the rail or road authority.

Table C3.2 Acceptable noise levels within a road or railway attenuation area

Roads	Railways
pressure levels for each of the one-hour periods between	A 24-hour Leq and Lmax noise level of 65 dB(A) and 87dB(A) Lmax assessed as a single event maximum sound pressure level.



Regarding indoor amenity, AS21071 is referred to for indoor noise level criteria. For houses or apartments near major roads, criteria are specified as:

Living areas (day time) 35 - 45 dBA Lea Sleeping areas (night time) 35 - 40 dBA Leg

Indoor noise levels of 35 – 40 dBA are then deemed appropriate for both day and night time periods.

It is noted that these criteria are applicable at a height of 1.2 m, and a distance of 1 m from the nearest residential facade, as per the Tas, Noise Measurement Procedures Manual 20082.

2.1. Project Criteria

As such, the applicable criteria for this project are taken as:

External Noise Level L10_{18-hour} \leq 63 dBA, and Internal Noise Level \leq 40 dBA. Lea

3. TRAFFIC NOISE LEVELS

On-site measurements were made over a 30-minute period on Friday the 6th of January 2023, at peak hour in the morning (around 9:00AM). Measurements used Svan Type 1 sound level meters, logging in A-weighted decibels with a Fast response time. The data set comprised overall levels, onethird octave spectra and full statistical data. Two measurement locations were used, as shown in Figure 1.1, and described as follows.

Location A - North-East site boundary, 2.2m above ground level (0.2m above barrier).

Location B - 3m inside the boundary, 1.2m above existing ground level.

Location A has direct line of sight to highway traffic, and thus represents worst-case. However, Location B has no direct line of sight to the highway traffic being shielded by the existing barrier.

The measured noise levels are summarised in Table 3.1 below.

В

Sound Pressure Level, [dBA] Location L10_{18-hour,Adj} L10_{30-min} Leq_{30-min} 73.3 Α 70.7 74.7

61.3

58.5

61.6

TABLE 3.1: SUMMARY OF MEASURED NOISE LEVELS

The CoRTN³ algorithms were used to predict the difference between the peak-hour noise level (Leg) and the L10_{18-hour}. The predicted L10_{18-hour} was 1.1 dB lower than the peak hour level, and thus the L10_{18-hour} is taken as 72.2 dBA_{Adj}. As per the Tas Noise Measurements Procedure Manual, an adjustment of +2.5 dBA must be applied due to the measurements being obtained in free space. This adjustment is to account for reflections from the facade once the residential dwellings have been constructed and is applied prior to assessment against the criteria. Adjustments are applied to both locations A and B. The resulting, adjusted noise levels are presented in the right hand column of Table 3.1. The measured noise spectrum for locations A and B after adjustments is shown below in Figure 3.1, this Figure shows the attenuation due to the existing barrier.

¹ AS/NZS 2107:2016 Acoustics - Recommended design sound levels and reverberation times for building interiors, Standards Australia, 2016.

² Noise Measurement Procedures Manual, Tasmania, 2008

³ Calculation of Road Traffic Noise (CoRTN), UK Department of Transport, 1988

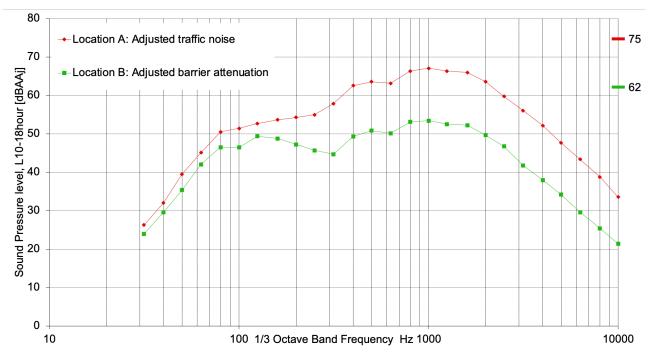


FIGURE 3.1: MEASURED TRAFFIC NOISE SPECTRUM

Figure 3.2, below, shows the site with the existing barrier along the eastern boundary.



FIGURE 3.2: SITE AND EXISTING BARRIER - LOOKING NORTH



4. DISCUSSION

The measurements demonstrate that the (adjusted) noise levels on the boundary of the site, and at the location of the nearest proposed residential facade are 74.7 and 62.6 dBA_{Adj}, L10_{18hour}, respectively. As such, the existing barrier is providing sufficient screening to reduce external noise levels to below the relevant external criterion from Table C3.2 of the Scheme.

The peak-hour ambient noise level at the location of the nearest proposed facade is 61.6 dBA_{Adj}, and thus, a noise level reduction of nominally 21.6 dB is required to achieve appropriate internal noise levels under AS2107.

5. RECOMMENDATIONS

It is noted that the traffic noise from the Tasman Highway is broadband, with noise in the 1000Hz to 2000Hz range being dominant (see Figure 3.1) typical of high-speed tyre noise. Therefore, the following mitigation measures are required:

• The existing barrier along the eastern boundary of the site (bordering the Booker Highway) must remain in place.

As the external noise levels are below the Acceptable Solutions criteria, no additional noise mitigation is required to demonstrate compliance with the Scheme. However, the following is *recommended* to ensure a high level of occupant amenity:

- The facade construction on the northern, eastern and southern sides of the proposed dwellings must achieve a minimum sound isolation rating of R_w 35. This may be achieved by various combinations of the building construction layout, with the following constructions appropriate.
 - 6mm Float / 12mm gap / 6mm Float is appropriate. Note that any operable windows will require full perimeter seals.
 - Typical wall construction with Colorbond, timber or cement sheet external linings, 90 mm cavity with insulations, and 10 mm plasterboard internal linings will achieve this rating.
 - Doors facing the highway should have solid core and seals around all jambs.
- It is recommended that outdoor entertainment areas be on the opposite side of the dwelling to the highway. Note that this is not strictly required.

6. ASSESSMENT

Provided the construction requirements outlined in section 5 are implemented, it is concluded that the site satisfies the external and internal noise level criteria, and there the proposal is deemed to comply with clause C3.6.1 of the *Tasmanian Planning Scheme - Glenorchy*.

Should you have any queries, please do not hesitate to contact me directly.

Kind regards,

Samuel Williamson

(NOISE VIBRATION CONSULTING)