

### **DEVELOPMENT APPLICATION**

**APPLICATION NUMBER:** PLN-24-309

**PROPOSED DEVELOPMENT:** New outbuilding, addition to driveway and

demolition

**LOCATION:** 39 Goodwood Road Goodwood

**APPLICANT:** P & J Sheds Pty Ltd

**ADVERTISING START DATE:** 08/01/2025

**ADVERTISING EXPIRY DATE:** 21/01/2025

Plans and documentation are available for inspection at Council's Offices, located at 374 Main Road, Glenorchy between 8.30 am and 5.00 pm, Monday to Friday (excluding public holidays) and the plans are available on Glenorchy City Council's website (<a href="www.gcc.tas.gov.au">www.gcc.tas.gov.au</a>) until 21/01/2025.

During this time, any person may make representations relating to the applications by letter addressed to the Chief Executive Officer, Glenorchy City Council, PO Box 103, Glenorchy 7010 or by email to <a href="mailto:gccmail@gcc.tas.gov.au">gccmail@gcc.tas.gov.au</a>.

Representations must be received by no later than 11.59 pm on **21/01/2025**, or for postal and hand delivered representations, by 5.00 pm on **21/01/2025**.

GLENORCHY CITY COUNCIL
PLANNING SERVICES

APPLICATION No.: PLN-24-309

**DATE RECEIVED**: 16/12/2024

# DEMOLITION OF EXISTING OUTBUILDINGS NEW OUTBUILDING / GARAGE 39 GOODWOOD ROAD, GOODWOOD, 7010 FOR R. GRIFFIN \$ HOMES TASMANIA

CERTIFICATE OF TITLE: VOLUME - 59735 FOLIO - 19

PID: 5371732 LAND AREA: 617m<sup>2</sup>

PLANNING SCHEME: TASMANIAN PLANNING SCHEME

GLENORCHY LOCAL PROVISIONS SCHEDULE

ZONE: 8. GENERAL RESIDENTIAL

OVERLAYS: NIL

SOIL CLASSIFICATION: ASSUMED M

WIND REGION: A

TERRAIN CATEGORY: TC 2.38 IMPORTANCE LEVEL: 2 (DOMESTIC)

SHIELDING: 0.85 TOPOGRAPHY: I

BAL: NOT REQUIRED (CLASS I OA STRUCTURE NOT WITHIN AN AREA IDENTIFIED

BY COUNCIL BUSHFIRE MAPP AS BEING BUSHFIRE PRONE)

## INDEX OF DRAWINGS - BY ADRIAN BROWN CC6003R

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PAGE 5 - SEWER MAIN LOCCATION & SECTION DETAIL 1:100 \$ 1:50

PAGE 6 - PLUMBING PLAN 1:200

PAGE 7 - STORMWATER CONCEPT PLAN 1:200

ADDITIONAL DRAWINGS / ENGINEERING BY NORTHERN CONSULTING ENGINEERS

JOB NO - 100606



GLENORCHY CITY COUNCIL PLANNING SERVICES

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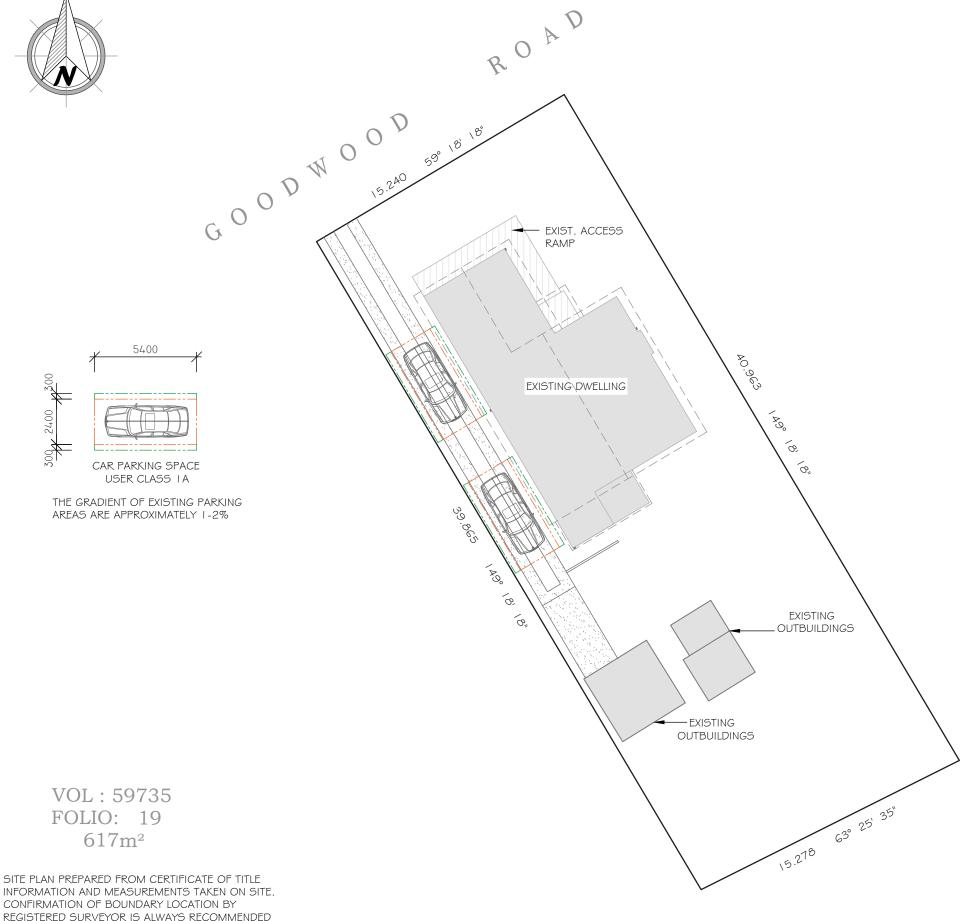
EXISTING DWELLING AREA: 108m2

LOT AREA: 617m<sup>2</sup>

" ACCESS RAMP \$ LANDING AREA: 15.2m<sup>2</sup>

" OUTBUILDINGS: 27.4m<sup>2</sup>

EXISTING SITE COVER: 150.6m2 OR 24.4%



INFORMATION AND MEASUREMENTS TAKEN ON SITE. CONFIRMATION OF BOUNDARY LOCATION BY REGISTERED SURVEYOR IS ALWAYS RECOMMENDED PRIOR TO CONSTRUCTION AND IS THE RESPONSIBILITY OF THE PROPERTY OWNER.

SITE PLAN (EXISTING) 1:200

P&J SHEDS PTY LTD. 38 McIntyre Street, Mornington, TAS, 7018. P: (03) 62 44 4300 F: (03) 6244 4355 E: admin@fairdinkumhobart.com.au ABN: 45109681263 THIS DRAWING IS THE PROPERTY OF P&J SHEDS. © 2024

Document Set ID: 3448597 Version: 2, Version Date: 06/01/2025 39 GOODWOOD ROAD, GOODWOOD, 7010

SCALE: 1:200 16th DECEMBER 2024

PROPOSAL : DEMOLITION OF EXISTING OUTBUILDINGS

NEW OUTBUILDING / GARAGE

R. GRIFFIN \$ HOMES TASMANIA

DATE:

AMENDED:

OWNER:

ADDRESS:

DRAWN BY: A. BROWN CC6003R

PAGE: 01/07 JOB NO: 100606

GLENORCHY CITY COUNCIL PLANNING SERVICES

LOT AREA: 617m<sup>2</sup>

APPLICATION No.: PLN-24-309

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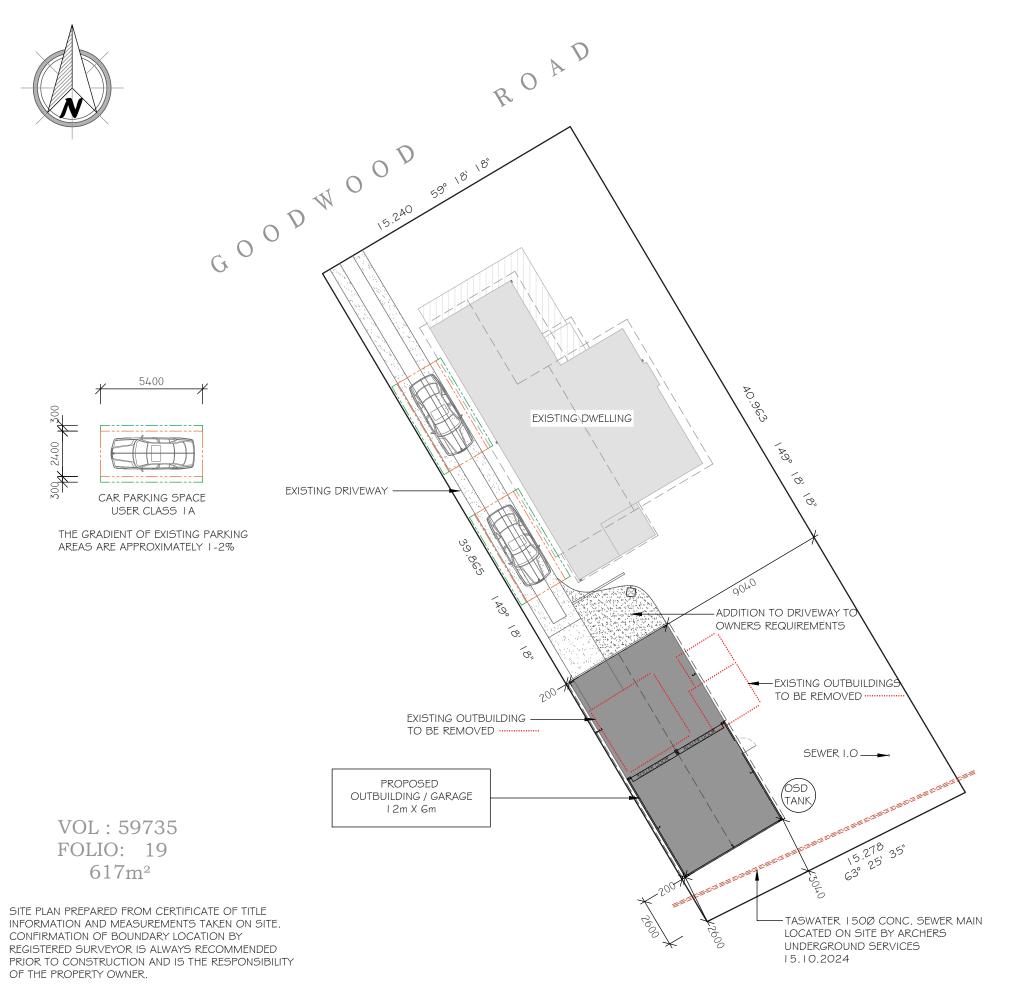
EXISTING DWELLING AREA: 108m<sup>2</sup>

" ACCESS RAMP \$ LANDING AREA: 15.2m<sup>2</sup>

EXISTING OUTBUILDINGS TO BE REMOVED: 27.4m<sup>2</sup>

PROPOSED OUTBUILDING / GARAGE AREA: 72m²

PROPOSED SITE COVER: 195.2m<sup>2</sup> or 31.6%



SITE PLAN (PROPOSED) 1:200

P&J SHEDS PTY LTD. 38 McIntyre Street, Mornington, TAS, 7018. P: (03) 62 44 4300 F: (03) 6244 4355 E: admin@fairdinkumhobart.com.au ABN: 45109681263 THIS DRAWING IS THE PROPERTY OF P&J SHEDS. © 2024

Document Set ID: 3448597 Version: 2, Version Date: 06/01/2025 PROPOSAL: DEMOLITION OF EXISTING OUTBUILDINGS NEW OUTBUILDING / GARAGE

OWNER: R. GRIFFIN & HOMES TASMANIA

ADDRESS: 39 GOODWOOD ROAD, GOODWOOD, 7010

SCALE: 1:200

DATE: 16th DECEMBER 2024

AMENDED:

DRAWN BY: A. BROWN CC6003R

PAGE: 02/07 JOB NO: 100606 NATURAL GROUND HEIGHT ABOVE
NATURAL GROUND LEVEL
3280


COTOSE CKEVAN

SIDE
BOUNDARY

CA445


AS SIDE
CA445

NORTH WEST ELEVATION

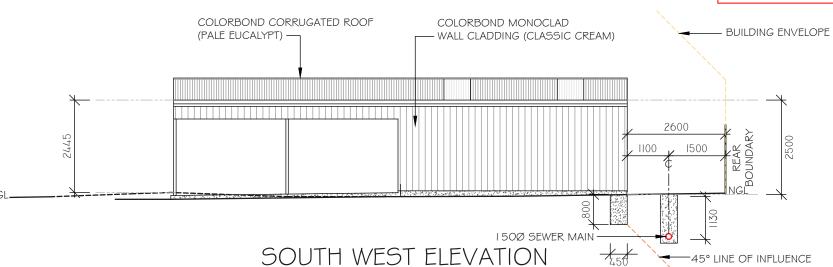

TASWATER 150Ø CONC. SEWER MAIN LOCATED ON SITE BY ARCHERS UNDERGROUND SERVICES 15.10.2024

SEE SEWER MAIN DETAIL ON PAGE 05/06

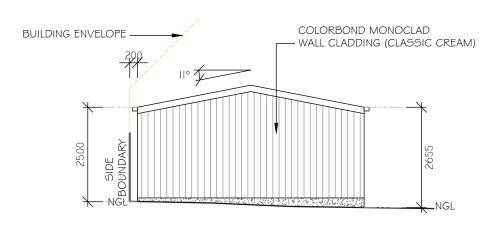

# SOUTH EAST ELEVATION

COLOUR'S (COLORBOND®):

EXT. WALLS

ROOF

ROLLER DOORS

PALE EUCALYPT

PA DOOR

GUTTER

CORNER FLASH

BARGE FLASHING - PALE EUCALYPT

OPENING FLASH

- CLASSIC CREAM


- PALE EUCALYPT

- CLASSIC CREAM

BARGE FLASHING - PALE EUCALYPT

OPENING FLASH

- PALE EUCALYPT

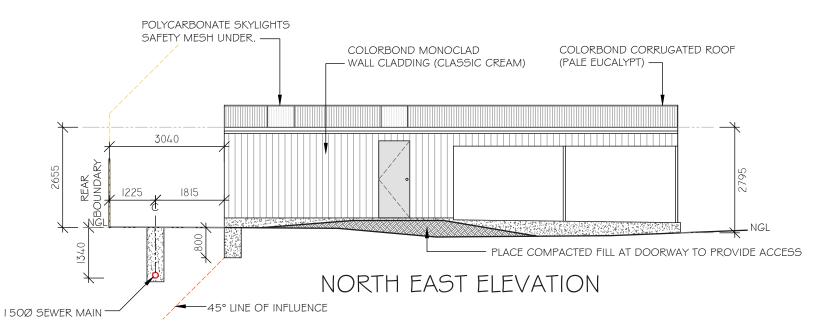

TASWATER 150Ø CONC. SEWER MAIN LOCATED ON SITE BY ARCHERS UNDERGROUND SERVICES 15.10.2024

ALL HEIGHTS SHOWN ARE ABOVE NATURAL GROUND LEVEL.

ACTUAL HEIGHTS OF WALLS ABOVE CONCRETE SLAB ARE: SIDE WALL HEIGHT - 2400mm
END WALL HEIGHT TO APEX - 2983mm

PROPOSAL: DEMOLITION OF EXISTING OUTBUILDINGS NEW OUTBUILDING / GARAGE

OWNER: R. GRIFFIN & HOMES TASMANIA

ADDRESS: 39 GOODWOOD ROAD, GOODWOOD, 7010

SCALE: 1:100

DATE: 16th DECEMBER 2024

AMENDED:


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PAGE: 03/07 JOB NO: 100606

REFER TO DRAWINGS BY NORTHERN CONSULTING FOR ALL MEMBER AND MATERIAL DETAILS AS WELL AS FOOTING DESIGN AND SPECIFICATIONS.

# ELEVATIONS 1:100



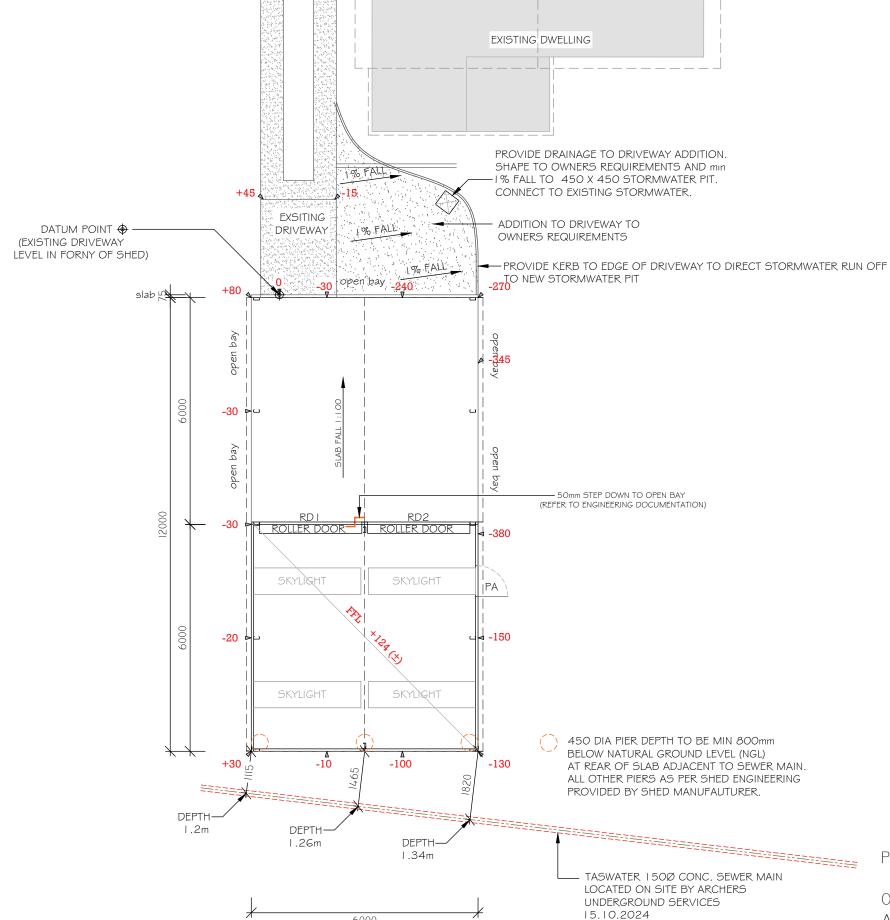

### WINDOW & DOOR SCHEDULE

	_ID	HEIGHT	WIDTH
ACCESS DOOR	PA	2040mm	8 I Omm
ROLLER DOORS	RD I RD2	l 970mm l 970mm	2710mm 2710mm

GLENORCHY CITY COUNCIL
PLANNING SERVICES

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OWNER: R. GRIFFIN & HOMES TASMANIA

ADDRESS: 39 GOODWOOD ROAD, GOODWOOD, 7010

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TASWATER 150Ø CONC. SEWER MAIN LOCATED ON SITE BY ARCHERS UNDERGROUND SERVICES 15.10.2024

-70

DEPTH

1.26m

1.2m

SEE DETAIL BELOW

### NATURAL GROUND LEVELS

450 DIA PIER DEPTH TO BE MIN 800mm
BELOW NATURAL GROUND LEVEL (NGL)
AT REAR OF SLAB ADJACENT TO SEWER MAIN.
ALL OTHER PIERS AS PER SHED ENGINEERING
PROVIDED BY SHED MANUFAUTURER.

SECTION DETAIL

SECTION DETAIL

ON 1500 DIN 150mm CONC. SEWER MAIN INVERT 1.2m BELOW NGL

TASWATER 1500 CONC. SEWER MAIN LOCATED ON SITE BY ARCHERS UNDERGROUND SERVICES 15.10.2024

-20

SEWER MAIN LOCATION

 ${\tt PROPOSAL}: {\tt DEMOLITION} \ {\tt OF} \ {\tt EXISTING} \ {\tt OUTBUILDINGS}$ 

NEW OUTBUILDING / GARAGE

OWNER: R. GRIFFIN \$ HOMES TASMANIA

ADDRESS: 39 GOODWOOD ROAD, GOODWOOD, 7010

SCALE: 1:100 \$ 1:50

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CONSTRUCTION GENERALLY:

ALL CONSTRUCTION TO BE IN ACCORDANCE WITH CURRENT BUILDING REGULATIONS BUILDING CODE OF AUSTRALIA (B.C.A.), RELEVANT AUSTRALIAN STANDARDS AND LOCAL AUTHORITY REQUIREMENTS.

SITE PREPARATION AND EXCAVATION TO COUNCIL AND B.C.A REQUIREMENTS.

CONCRETE FOOTINGS TO AS 2870. I AND ENGINEER SPECIFICATIONS. UNLESS OTHERWISE SPECIFIED, FOOTINGS 20MPA / SLAB 25MPA.

STRUCTURAL; DETAILS AND CERTIFICATION AS PER 'FAIR DINKUM BUILDS' DOCUMENTATION.

BUILDER TO VERIFY ALL DIMENSIONS AND DETAILS ON THIS SET OF PLANS PRIOR TO COMMENCEMENT OF WORK ON SITE.


USE WRITTEN DIMENSIONS IN PREFERENCE TO MEASURING OFF THE PLAN.

COUNCIL / CONTRACTOR TO CONTACT P\$J SHEDS IF NECESSARY INFORMATION IS NOT PROVIDED ON THIS SET OF PLANS.

ALL PLUMBING TO BE IN ACCORDANCE WITH AS 3500. TAS PLUMBING CODE AND LOCAL AUTHORITY REQUIREMENTS.

I OOdia UPVC STORM WATER TO EXISTING STORM WATER CONNECTION. PLUMBER TO VERIFY CONNECTION LOCATION WITH OWNER.

FIRST INSPECTION OPENING TO BE RAISED TO FINISHED GROUND LEVEL.

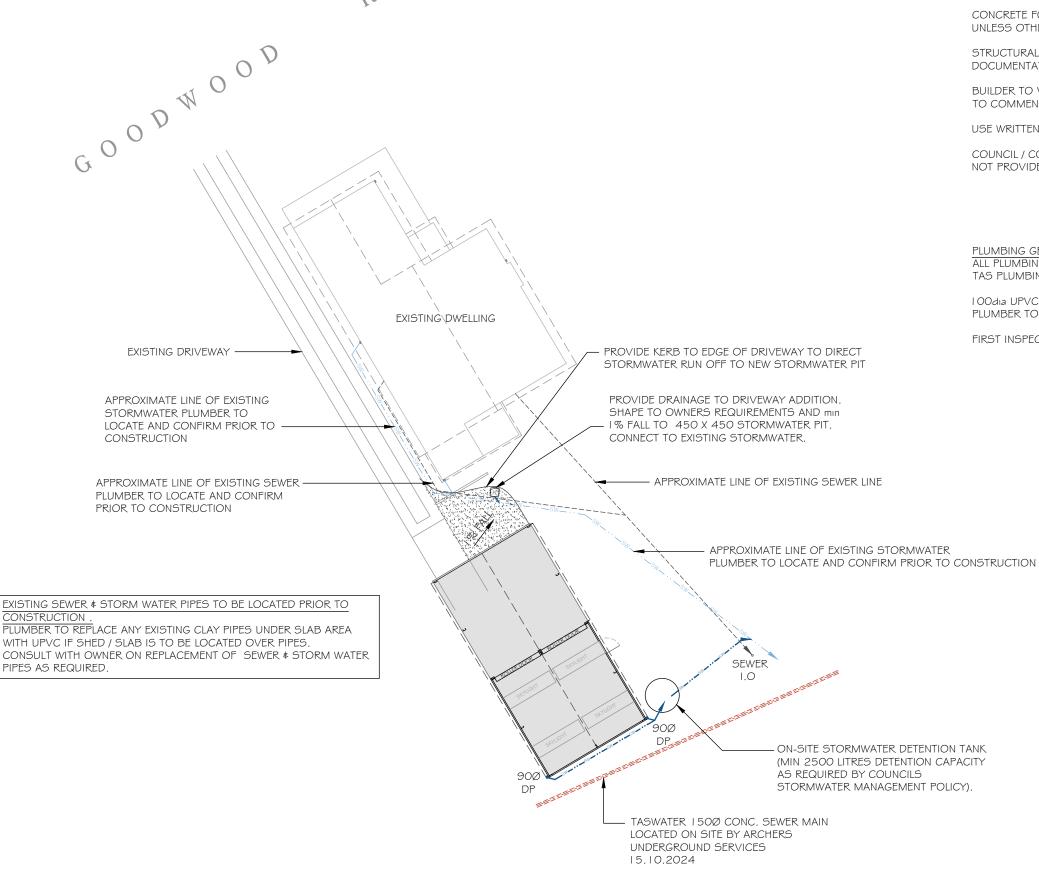

PLUMBER TO REPLACE ANY EXISTING CLAY PIPES UNDER SLAB AREA

WITH UPVC IF SHED / SLAB IS TO BE LOCATED OVER PIPES. CONSULT WITH OWNER ON REPLACEMENT OF SEWER \$ STORM WATER PIPES AS REQUIRED.

> PROPOSAL : DEMOLITION OF EXISTING OUTBUILDINGS NEW OUTBUILDING / GARAGE

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ADDRESS: 39 GOODWOOD ROAD, GOODWOOD, 7010

SCALE: 1:200

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PLUMBING PLAN 1:200

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LOT AREA: 617m²

EXISTING DWELLING AREA: 108m2

" ACCESS RAMP \$ LANDING AREA: 15.2m<sup>2</sup>
EXISTING OUTBUILDINGS TO BE REMOVED: 27.4m<sup>2</sup>

PROPOSED OUTBUILDING / GARAGE AREA: 72m²

PROPOSED SITE COVER: 195.2m<sup>2</sup> or 31.6%

ADDITIONAL IMPERVIOUS SURFACE 92m<sup>2</sup>

### ON-SITE STORMWATER DETENTION REQUIREMENTS

THE PROPOSED DEVELOPMENT WILL RESULT IN ADDITIONAL IMPERVIOUS AREA OF APPROXIMATELY 92m². THE GCC STORMWATER MANAGEMENT POLICY REQUIRES A MINIMUM OF 2500 LITRE ON SITE DETENTION.

ON-SITE STORMWATER DETENTION TANK (MIN 2500 LITRES DETENTION CAPACITY - AS REQUIRED BY COUNCILS STORMWATER MANAGEMENT POLICY).

SEWER I.O \_\_\_

TASWATER 1500 CONC. SEWER MAIN

LOCATED ON SITE BY ARCHERS

UNDERGROUND SERVICES

15.10.2024

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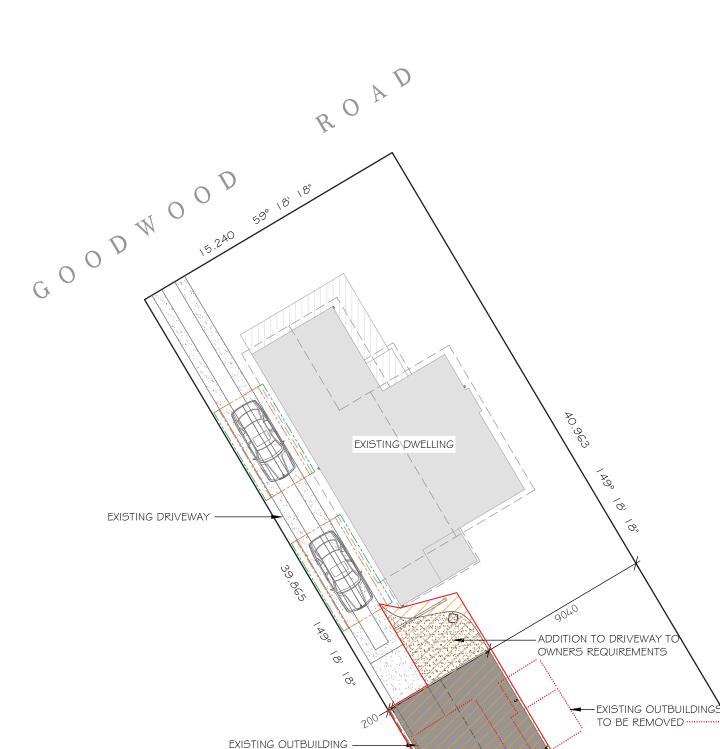
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TO BE REMOVED

PROPOSED

OUTBUILDING / GARAGE

12m X 6m

VOL: 59735 FOLIO: 19 617m<sup>2</sup>

SITE PLAN PREPARED FROM CERTIFICATE OF TITLE INFORMATION AND MEASUREMENTS TAKEN ON SITE. CONFIRMATION OF BOUNDARY LOCATION BY REGISTERED SURVEYOR IS ALWAYS RECOMMENDED PRIOR TO CONSTRUCTION AND IS THE RESPONSIBILITY OF THE PROPERTY OWNER.

# STORMWATER CONCEPT PLAN 1:200

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