GLENORCHY PLANNING AUTHORITY ATTACHMENTS MONDAY, 17 FEBRUARY 2025



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PLANNING

5.	PROPOSED USE AND DEVELOPMENT – MULTIPLE DWELLINGS (ONE
	EXISTING, ONE PROPOSED) – 2 NARELLE PLACE, CLAREMONT

1: GPA Attachment – 2 Narelle Place, Claremont......2

MULTIPLE DWELLING DEVELOPMENT (ONE NEW & ONE EXISTING)

PROJECT ADDRESS: 2 NARELLE PLACE, CLAREMONT, TAS 7011 OWNER: QUAN NGUYEN

SIK PONG HO, JAMES

E. INFO@JAMESHOARCHITECTURE.COM.AU P. 03 6231 9104 M. 0404 252 234

A. SUITE 14, LEVEL 1, MOONAH BUSINESS CENTRE, 113 MAIN ROAD, MOONAH 7000

BUILDING SERVICE PROVIDER 799235148 TAS ARCHITECT REGISTRATION NO. 1132

SITE INFORMATION

LOCATION 2 NARELLE PLACE, CLAREMONT, TAS 7011 TITLE REFERENCE

54722/10 5337497 833m²

LOCAL COUNCIL GLENORCHY CITY COUNCIL

PLANNING SCHEME TASMANIAN PLANNING SCHEME - GLENORCHY

OVERLAY

SITE COVERAGE

PROPERTY ID

SITE AREA

DESIGNER:

120m² **EXISTING HOUSE** PROPOSED DWELLING 105m²

205 / 833 = 24.6% (<50%)

IMPERVIOUS SURFACE 351 / 833

= 42.1% (>25%)

CLASS M

N1

SITE CLASSIFICATION:

WIND CLASSIFICATION (AS4055-2012): WIND REGION:


TERRAIN CATEGORY:

TC3 FS SHIELDING CLASSIFICATION: TOPOGRAPHIC CLASSIFICATION: TO

DESIGN WIND GUST SPEED (Vh, u): 34 M/SEC BAL LEVEL

N/A ALPINE AREA N/A CORROSION ENVIRONMENT N/A OTHER HAZARDS N/A

DRAWING SCHEDULE				
007_24_DA01	SITE PLAN & NOTES			
007_24_DA02	DEMOLITION PLAN			
007_24_DA03	PROPOSED FLOOR PLAN			
007_24_DA04	PROPOSED FLOOR PLAN			
007_24_DA05	PROPOSED FLOOR PLAN			
007_24_DA06	PROPOSED ELEVATIONS & SECTIONS			
007_24_DA07	PROPOSED ELEVATIONS & SECTIONS			

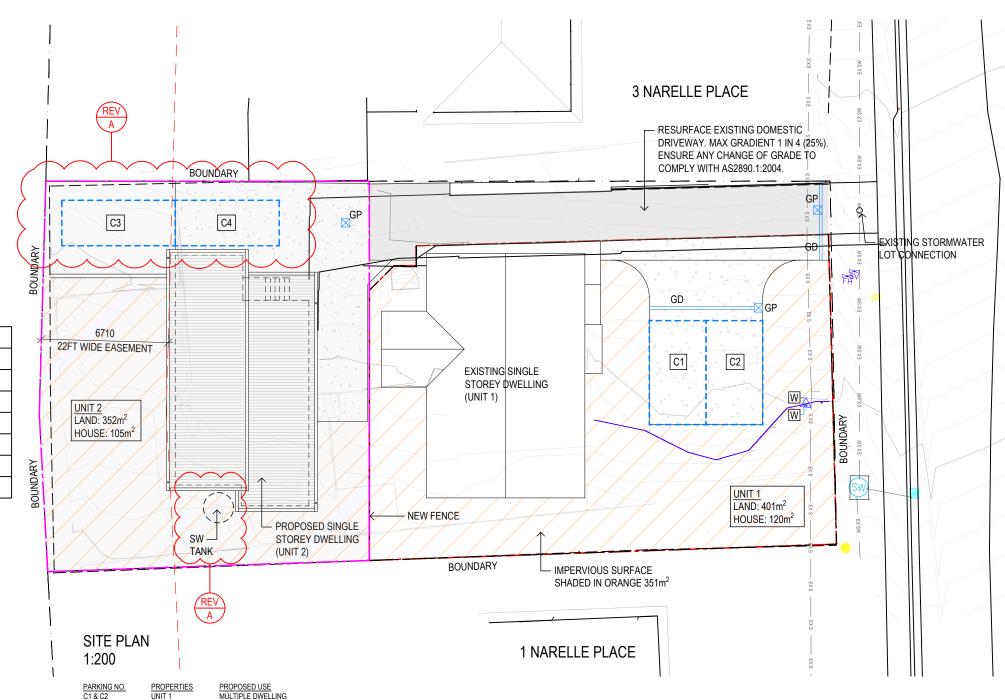

GLENORCHY CITY COUNCIL PLANNING SERVICES PLN-24-288

DATE RECEIVED: 17/12/2024



CONTRACTOR SHALL VERIFY ALL DIMENSIONS ON SITE BEFORE COMMENCING ANY WORK OR SHOP

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20.11.2024

REVISION

A DA RFI

PROJECT TITLE

MULTIPLE DWELLING

DEVELOPMENT (ONE NEW & ONE EXISTING)

PROJECT ADDRESS

2 NARELLE PLACE, CLAREMONT, TAS 7011

PROJECT NUMBER

JHA_007_24

CHECK BY

DRAWING TITLE


SITE PLAN AND NOTES

REV NO. SCALE AS SHOWN @A3 DRAWN BY

SEPTEMBER 2024

PROJECT NORTH



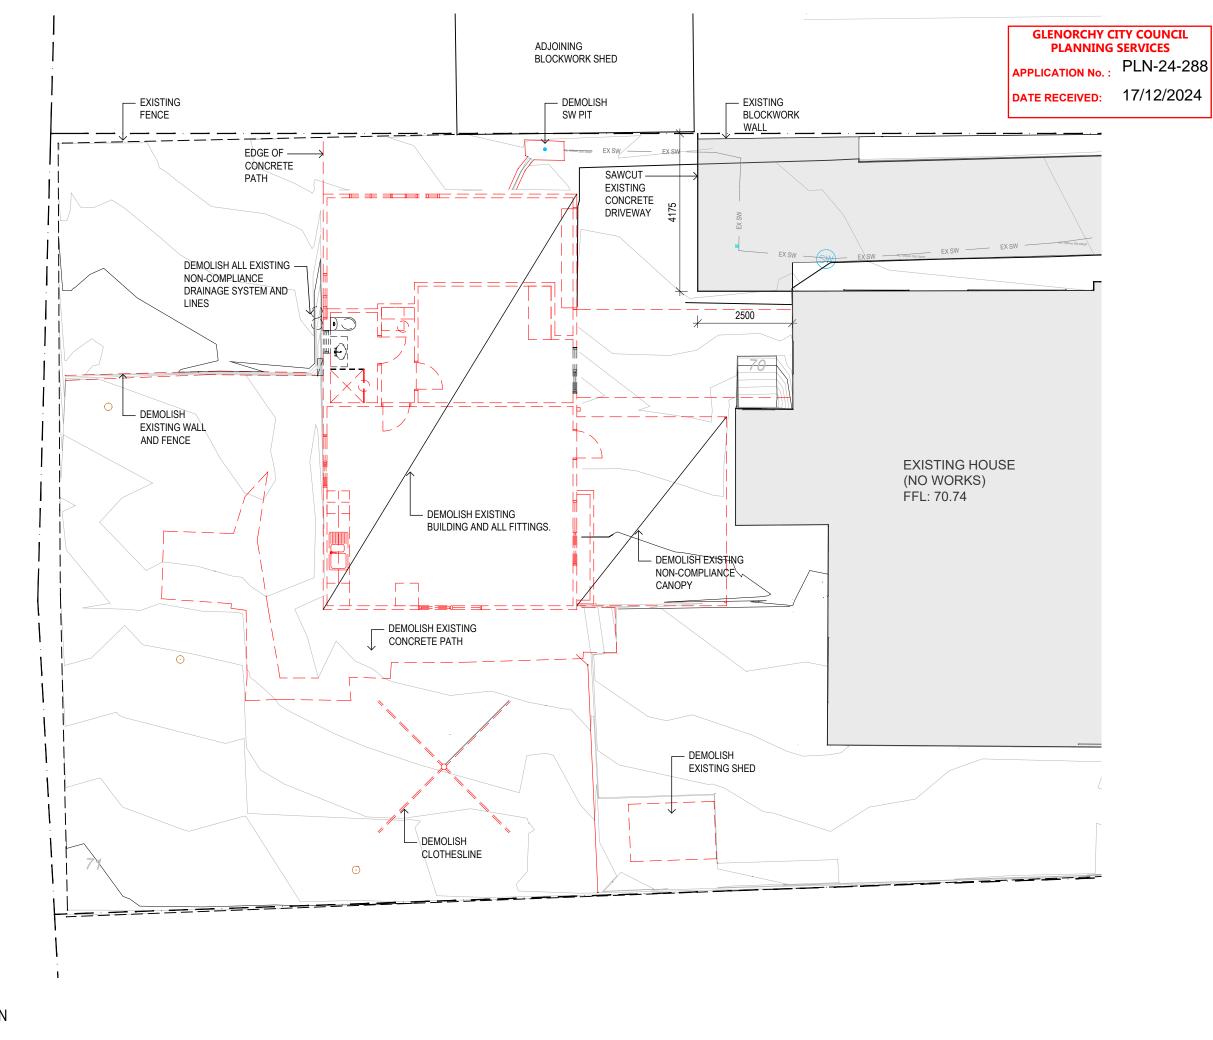

DEMOLITION PLAN 1:100

NOTE
CONTRACTOR TO ARRANGE ASBESTOS TESTING FOR EAVES, WALL & CEILING LINING, FLOOR FINISHES AND UNDERLAY PRIOR TO ANY DEMOLITION WORKS ON SITE.

Document Set ID: 3458990 Version: 3, Version Date: 00/02/2025 JAMES HO

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ARCHITECTURE

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A DA RFI 20.11.2024

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MULTIPLE DWELLING DEVELOPMENT (ONE NEW & ONE EXISTING)

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PROJECT NUMBER

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DRAWING TITLE


DEMOLITION PLAN

REV NO. SCALE AS SHOWN @A3 DRAWN BY CHECK BY DATE SEPTEMBER 2024

PROJECT NORTH





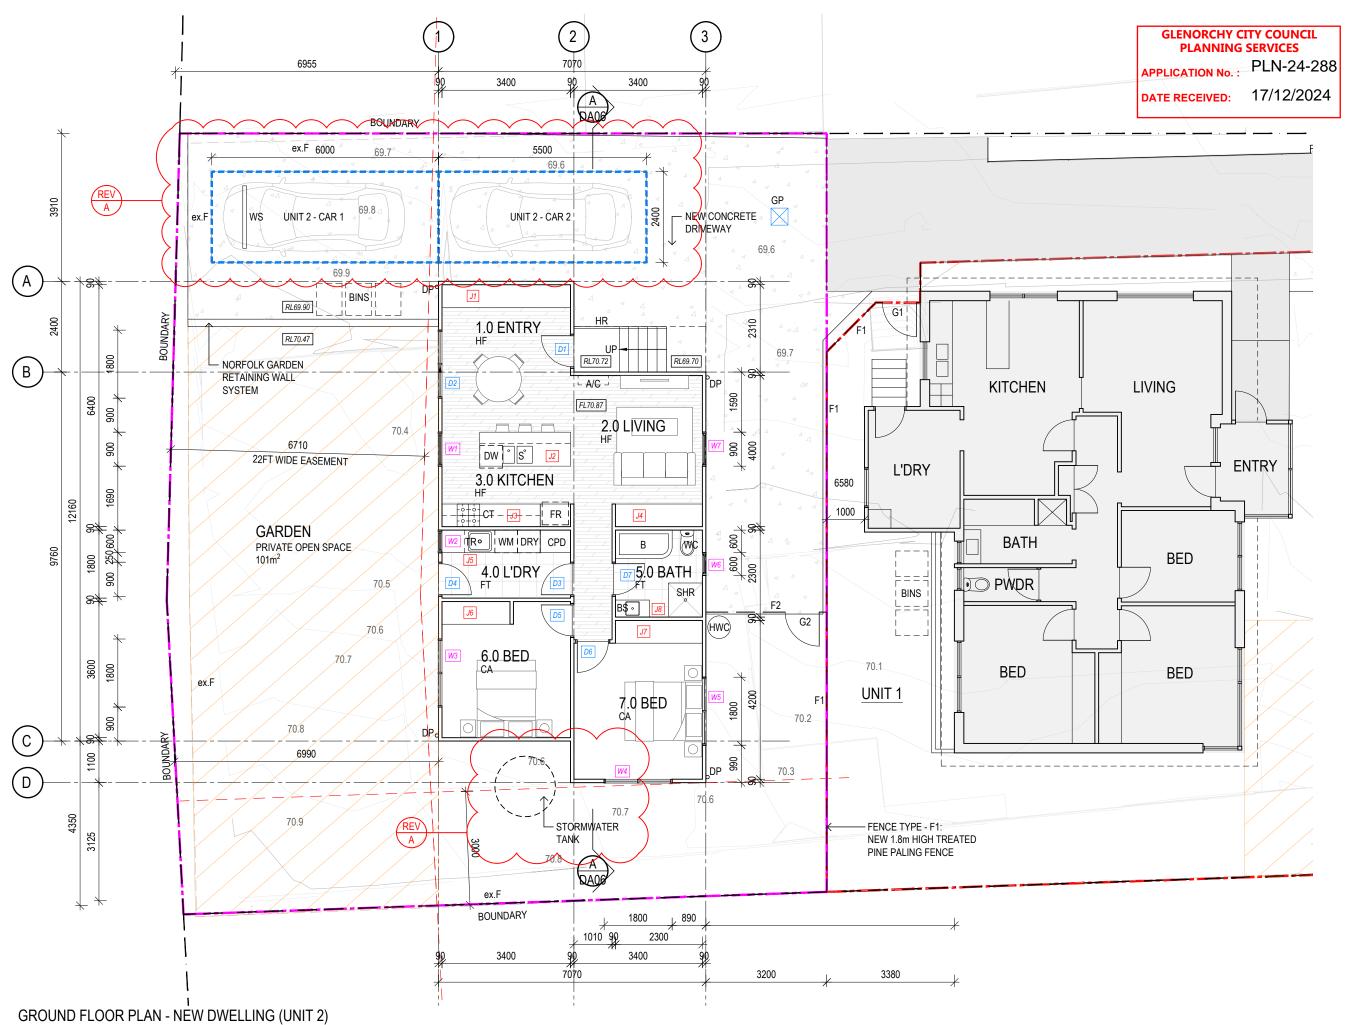

NOTE
OCATION OF PIPES, LOT CONNECTIONS AND MANHOLES WERE LOCATED BY ARTHUR MOEHRKE SURVEYS • REFER TO ARTHUR MOEHRKE SURVEYS DETAIL SURVEY H02407/01 DRAWING D01 DATED 24-07-2024 FOR DETAILS

JAMES HO ARCHITECTURE

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REVISION A DA RFI 20.11.2024

PROJECT TITLE MULTIPLE DWELLING

DEVELOPMENT (ONE NEW & ONE EXISTING)

PROJECT ADDRESS 2 NARELLE PLACE, CLAREMONT, TAS 7011

PROJECT NUMBER JHA_007_24

DRAWING TITLE

PROPOSED FLOOR PLAN

REV NO. SCALE AS SHOWN @A3 DRAWN BY CHECK BY DATE SEPTEMBER 2024


AIR CONDITIONING BATHTUB BASIN CONCRETE CARPET C CA CT DP DW FT FR HF S SHR TR WC WM WS COOKTOP DOWNPIPE DISH WASHER FLOOR TILE FRIDGE HYBRID FLOORING SHOWER LAUNDRY TROUGH TOILET SUITE WASHING MACHINE WHEELSTOP FULLY COMPLY

PROJECT NORTH





WITH AS2890.1:2004 2.4.5

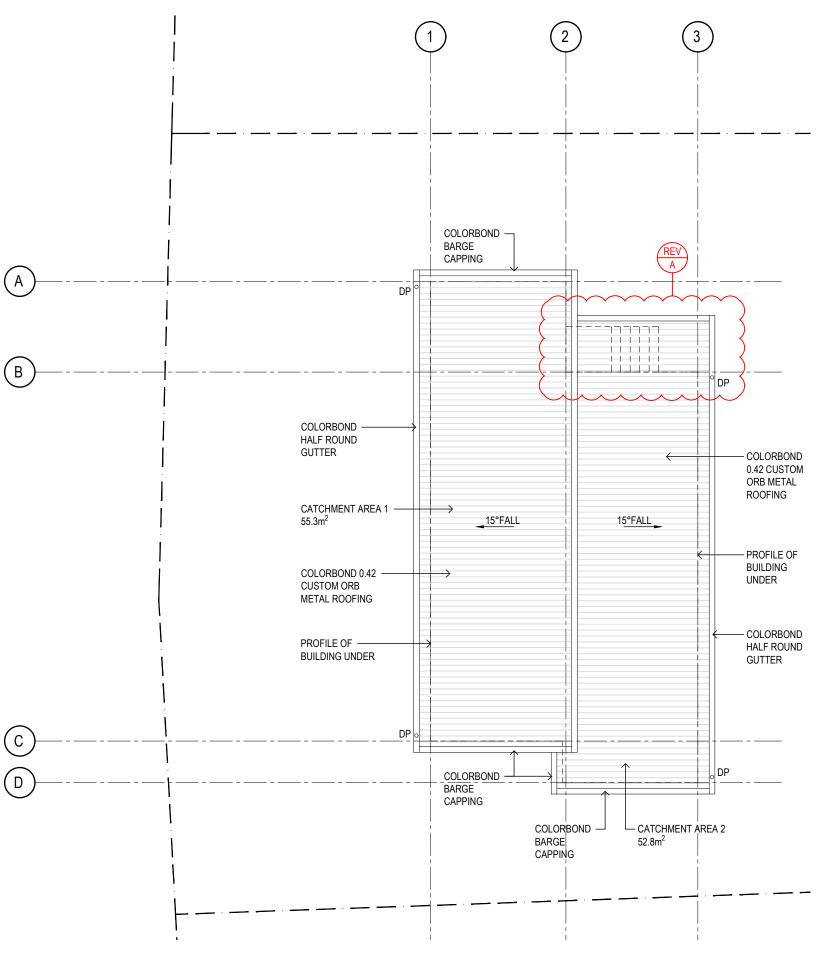

ROOF PLAN - NEW DWELLING 1:100

GLENORCHY CITY COUNCIL PLANNING SERVICES

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DEVELOPMENT (ONE NEW & ONE EXISTING)

PROJECT ADDRESS

2 NARELLE PLACE, CLAREMONT, TAS 7011

PROJECT NUMBER

JHA_007_24

DRAWING TITLE

PROPOSED FLOOR PLAN

REV NO.	А
SCALE	AS SHOWN @A3
DRAWN BY	AM
CHECK BY	-
DATE	SEPTEMBER 2024

DOWNPIPE & ROOF CATCHMENT AREA CALCULATION (NCC PART 3.5.2)

CATCHMENT AREA 1 66.3m² Ah Ac Gutter type Ε DRI

89.505m² 85 50

Acdp DPs required 1.79 DPs provided 2

CATCHMENT AREA 2 48.5m² Αh 65.48m² Ac Gutter type Ε DRI 85 Acdp 50 DPs required 1.31

2

DPs provided


Ah x SLOPE FACTOR 15° F=1.35 (AS/NZS 3500.3 - TABLE 3.2) CROSS SECTIONAL AREA (NCC TABLE 3.5.2.2b) DESIGN RAINFALL INTENSITY HOBART (NCC TABLE 3.5.3.1f) CATCHMENT AREA PER 90mm DOWNPIPE (NCC TABLE 3.5.3.2a)

AREA OF ROOF (INCLUDING 150mm HALF-ROUND GUTTER)

AREA OF ROOF (INCLUDING 150mm HALF-ROUND GUTTER) Ah x SLOPE FACTOR 15° F=1.35 (AS/NZS 3500.3 - TABLE 3.2) CROSS SECTIONAL AREA (NCC TABLE 3.5.2.2b) DESIGN RAINFALL INTENSITY HOBART (NCC TABLE 3.5.3.1f) CATCHMENT AREA PER 90mm DOWNPIPE (NCC TABLE 3.5.3.2a)

Ac/Acdp

PROJECT NORTH

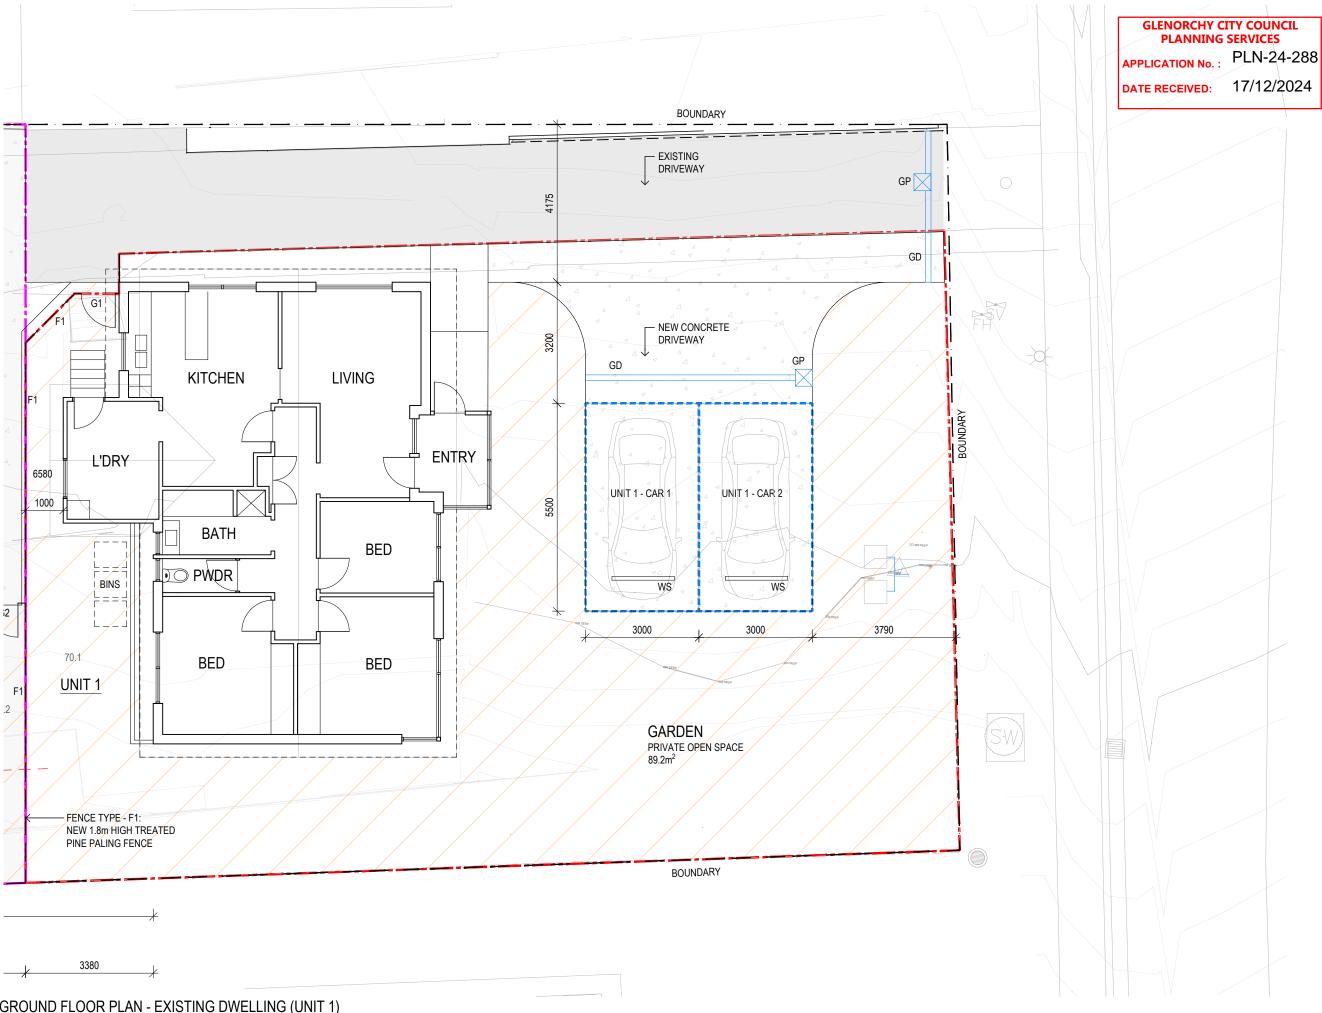

JAMES HO ARCHITECTURE

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DRAWING TITLE

PROPOSED FLOOR PLAN

REV NO. AS SHOWN @A3

DRAWN BY CHECK BY

DATE SEPTEMBER 2024

WHEELSTOP FULLY COMPLY WITH AS2890.1:2004 2.4.5

PROJECT NORTH




GROUND FLOOR PLAN - EXISTING DWELLING (UNIT 1) 1:100

NOTE

LOCATION OF PIPES, LOT CONNECTIONS AND MANHOLES WERE LOCATED BY ARTHUR MOEHRKE SURVEYS

REFER TO ARTHUR MOEHRKE SURVEYS DETAIL SURVEY H02407/01 DRAWING D01 DATED 24-07-2024 FOR DETAILS

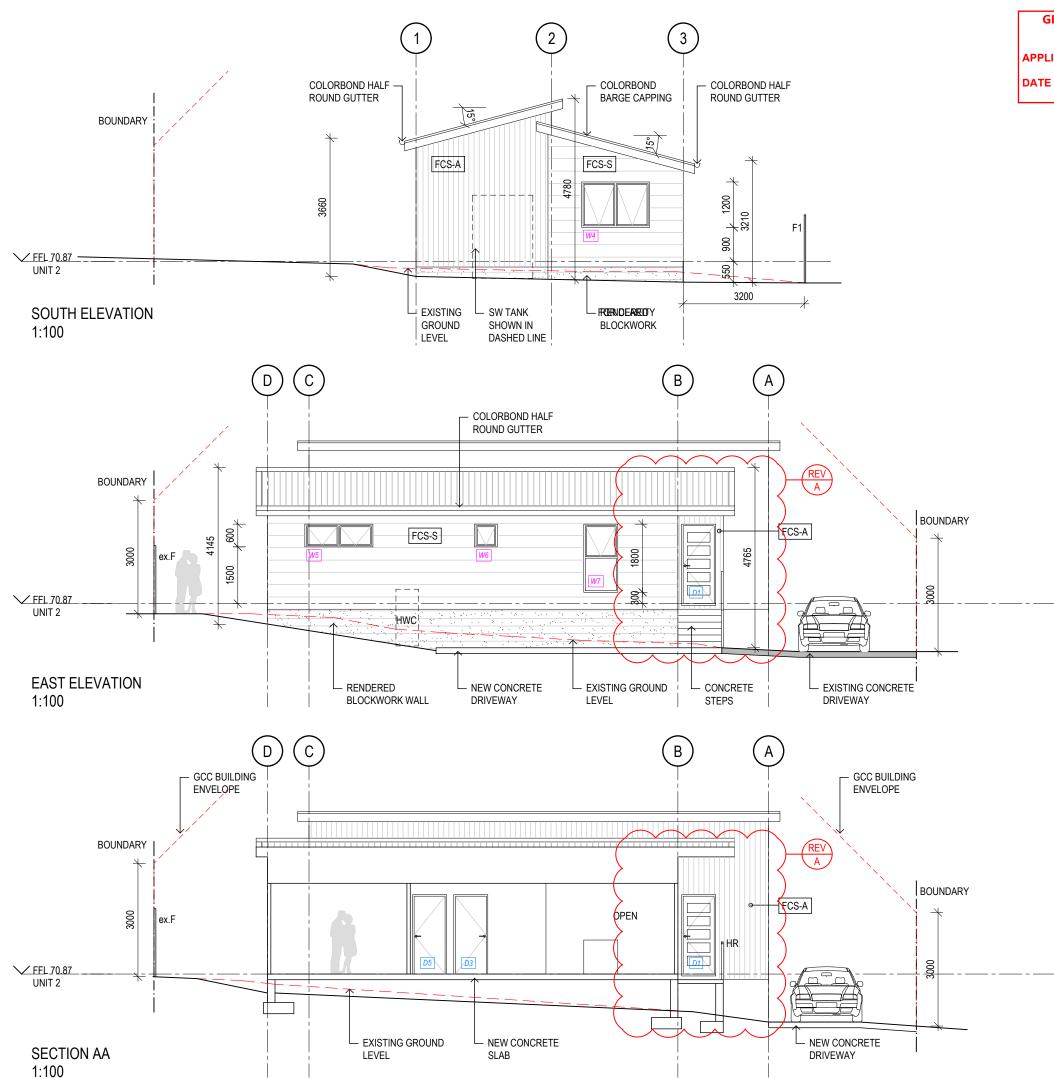

APPLICATION No.: PLN-24-288

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REVISION A DA RFI 20.11.2024

PROJECT TITLE

MULTIPLE DWELLING DEVELOPMENT (ONE NEW & ONE EXISTING)

PROJECT ADDRESS

2 NARELLE PLACE, CLAREMONT, TAS 7011

PROJECT NUMBER

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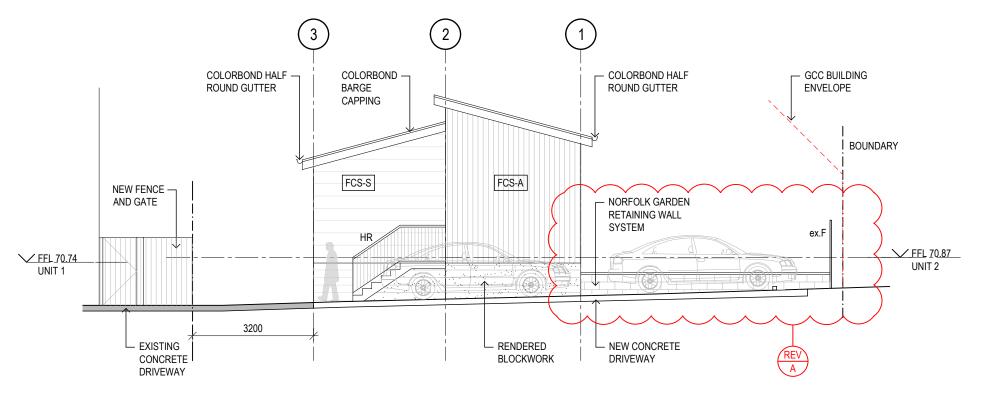
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PROPOSED ELEVATIONS & SECTIONS


REV NO.	А
SCALE	AS SHOWN @A3
DRAWN BY	AM
CHECK BY	-
DATE	SEPTEMBER 2024

DRAWING KEY

A/C DP ex.F FCS-A AIR CONDITIONING DOWNPIPE EXISTING PALING FENCE JAMES HARDIE AXON CLADDING SYSTEM. DULUX 'STEPNEY' FCS-S JAMES HARDIE STRIA CLADDING SYSTEM. DULUX 'DIESKAU' HR



NORTH ELEVATION 1:100

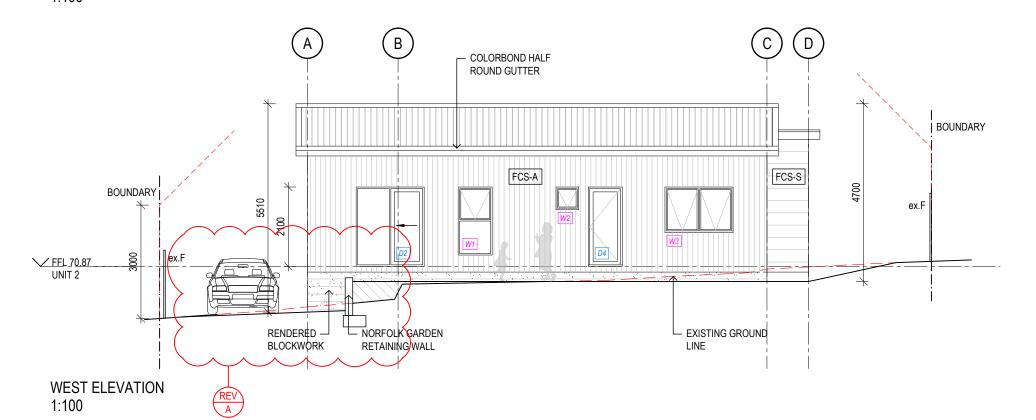

GLENORCHY CITY COUNCIL PLANNING SERVICES

APPLICATION No. : PLN-24-288

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Α	DA RFI	20.11.202

PROJECT TITLE

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2 NARELLE PLACE, CLAREMONT, TAS 7011

PROJECT NUMBER

JHA_007_24

DRAWING TITLE

PROPOSED ELEVATIONS & SECTIONS

REV NO.	А
SCALE	AS SHOWN @A3
DRAWN BY	AM
CHECK BY	-
DATE	SEPTEMBER 2024

DRAWING KEY

A/C AIR CONDITIONING
DP DOWNPIPE
ex.F EXISTING PALING FENCE
FCS-A JAMES HARDIE AXON CLADDING
SYSTEM. DULUX 'STEPNEY'
FCS-S JAMES HARDIE STRIA CLADDING
SYSTEM. DULUX 'DIESKAU'
HR 1m HIGH HANDRAIL

APPLICATION No.: PLN-24-288

DATE RECEIVED: 17/12/2024



A2416593T Residential Subdivision 2 Narelle Place, Claremont - Car Parking Assessment 1.4

25th November 2024

Glenorchy City Council PO Box 103 Glenorchy TAS 7010

Dear Sir / Madam,

<u>Car Parking Dispensation and B85 Car Swept Path Assessment associated with Proposed</u> Residential Subdivision at 2 Narelle Place, Claremont

1. Overview

We have been commissioned by James Ho Architecture undertake a car parking reduction assessment and a B85 car swept path assessment associated with a subdivision of a residential lot at 2 Narelle Place, Claremont to create 1 additional dwelling with 2 or more bedrooms at the rear of the existing dwelling.

2. Car Parking Requirements

Clause C2.5.1 A1 of the Glenorchy Council's Parking and Sustainable Transport Code states the number of on-site car parking spaces must be no less than the number specified in Table C2.1. Table C2.1 specifies the following car parking rates:

- Residential Tenant, if a 2 or more bedroom dwelling in a General Residential Zone (including all rooms capable of being used as a bedroom): 2 spaces per dwelling.
- Residential Visitor: 1 dedicated space per 4 dwellings (rounded up to the nearest whole number); or if on an internal lot or located at the head of a cul- de- sac, 1 dedicated space per 3 dwellings (rounded up to the nearest whole number).

The proposal comprises constructing 1 additional dwelling with more than 2-bedrooms. Each dwelling will be allocated 2 car parking space each. With 4 on-site car parking spaces for 2 dwellings with 2 or more bedrooms each, the applicant is seeking a dispensation of 1 visitor space.

3. B85 Car Swept Path Assessment

The proposed 4 car spaces can be satisfactorily accessed and internally manoeuvred for forward direction egress.

Level 3, 85 Macquarie Street, Hobart TAS 7000

Telephone: 03 6237 0012 hobart@mltraffic.com.au

Facsimile: 1300 739 523 www.mltraffic.com.au

APPLICATION No.: PLN-24-288

17/12/2024 DATE RECEIVED:



4. **External Car Park Impact**

There is ample kerbside parking (in excess of 18 spaces) on Narelle Place available within 50m of the site during and outside of normal business hours. At any point in time, there are between 1 and 3 cars parked on the street within the observed catchment, which has a capacity of 22 spaces - based on parallel parking space length of 6m and No Standing for 6m to the nearest tangent point of the kerb (where the straight section of kerb meets the curved section of kerb). Narelle Place can accommodate the 1-space visitor parking short-fall at all times.

The section of Narelle Place has an 8m wide carriageway along the straight (north-south orientated section) in the vicinity of the subject site, and a 7m wide carriageway along the looped section where the inside of the loop is a public open space. Such widths allow traffic to move in one direction at a time when there are cars parked on both sides of the carriageway. For the majority of time, cars are parked on one side of the carriageway, thereby allowing simultaneous bi-directional traffic.

Location	Capacity	Number of Parked Cars	
		Tuesday, 12Nov24, 12pm	Monday, 11Nov24, 8pm
West side, between Colston Street and the subject site	6 spaces	0 car	2 cars
East side, between Narelle Place (southern portion of loop) and Colson Street	4 spaces	0 car	0 car
West side, between the subject site and No.7 Narelle Place	5 spaces	1 car	1 car
East side, between the subject site and No.7 Narelle Place	0 space – on an inside curve	-	-
North side, No.14 Narelle Place and the subject site	4 spaces	0 car	0 car
South side, between No.14 Narelle Place and the subject site	3 spaces	0 car	0 car
Capacity of Kerbside Parking areas within 50m	22 spaces	1 car	3 cars
Number of Parked Cars within 50m Number of Vacant Spaces within 50m		1 car 21 spaces	3 cars 19 spaces

Figure 1: Street Parking Supply and Utilisation

Residential Subdivision A2416593T Residential Subdivision 2 Narelle Place, Claremont - Car Parking Assessment 1.4

APPLICATION No.: PLN-24-288

DATE RECEIVED: 17/12/2024



5. Conclusions

We are of the opinion that there is reasonable grounds for the dispensation of 1 on-site visitor parking space associated with the proposed residential subdivision. If you have any questions, please do not hesitate to contact me on 0413 295 325 and/or mlee@mltraffic.com.au.


Yours sincerely


Michael Lee, BEng (Monash, 1989)


Principals


Residential Subdivision ML
A2416593T Residential Subdivision 2 Narelle Place, Claremont - Car Parking Assessment 1.4 Page 3


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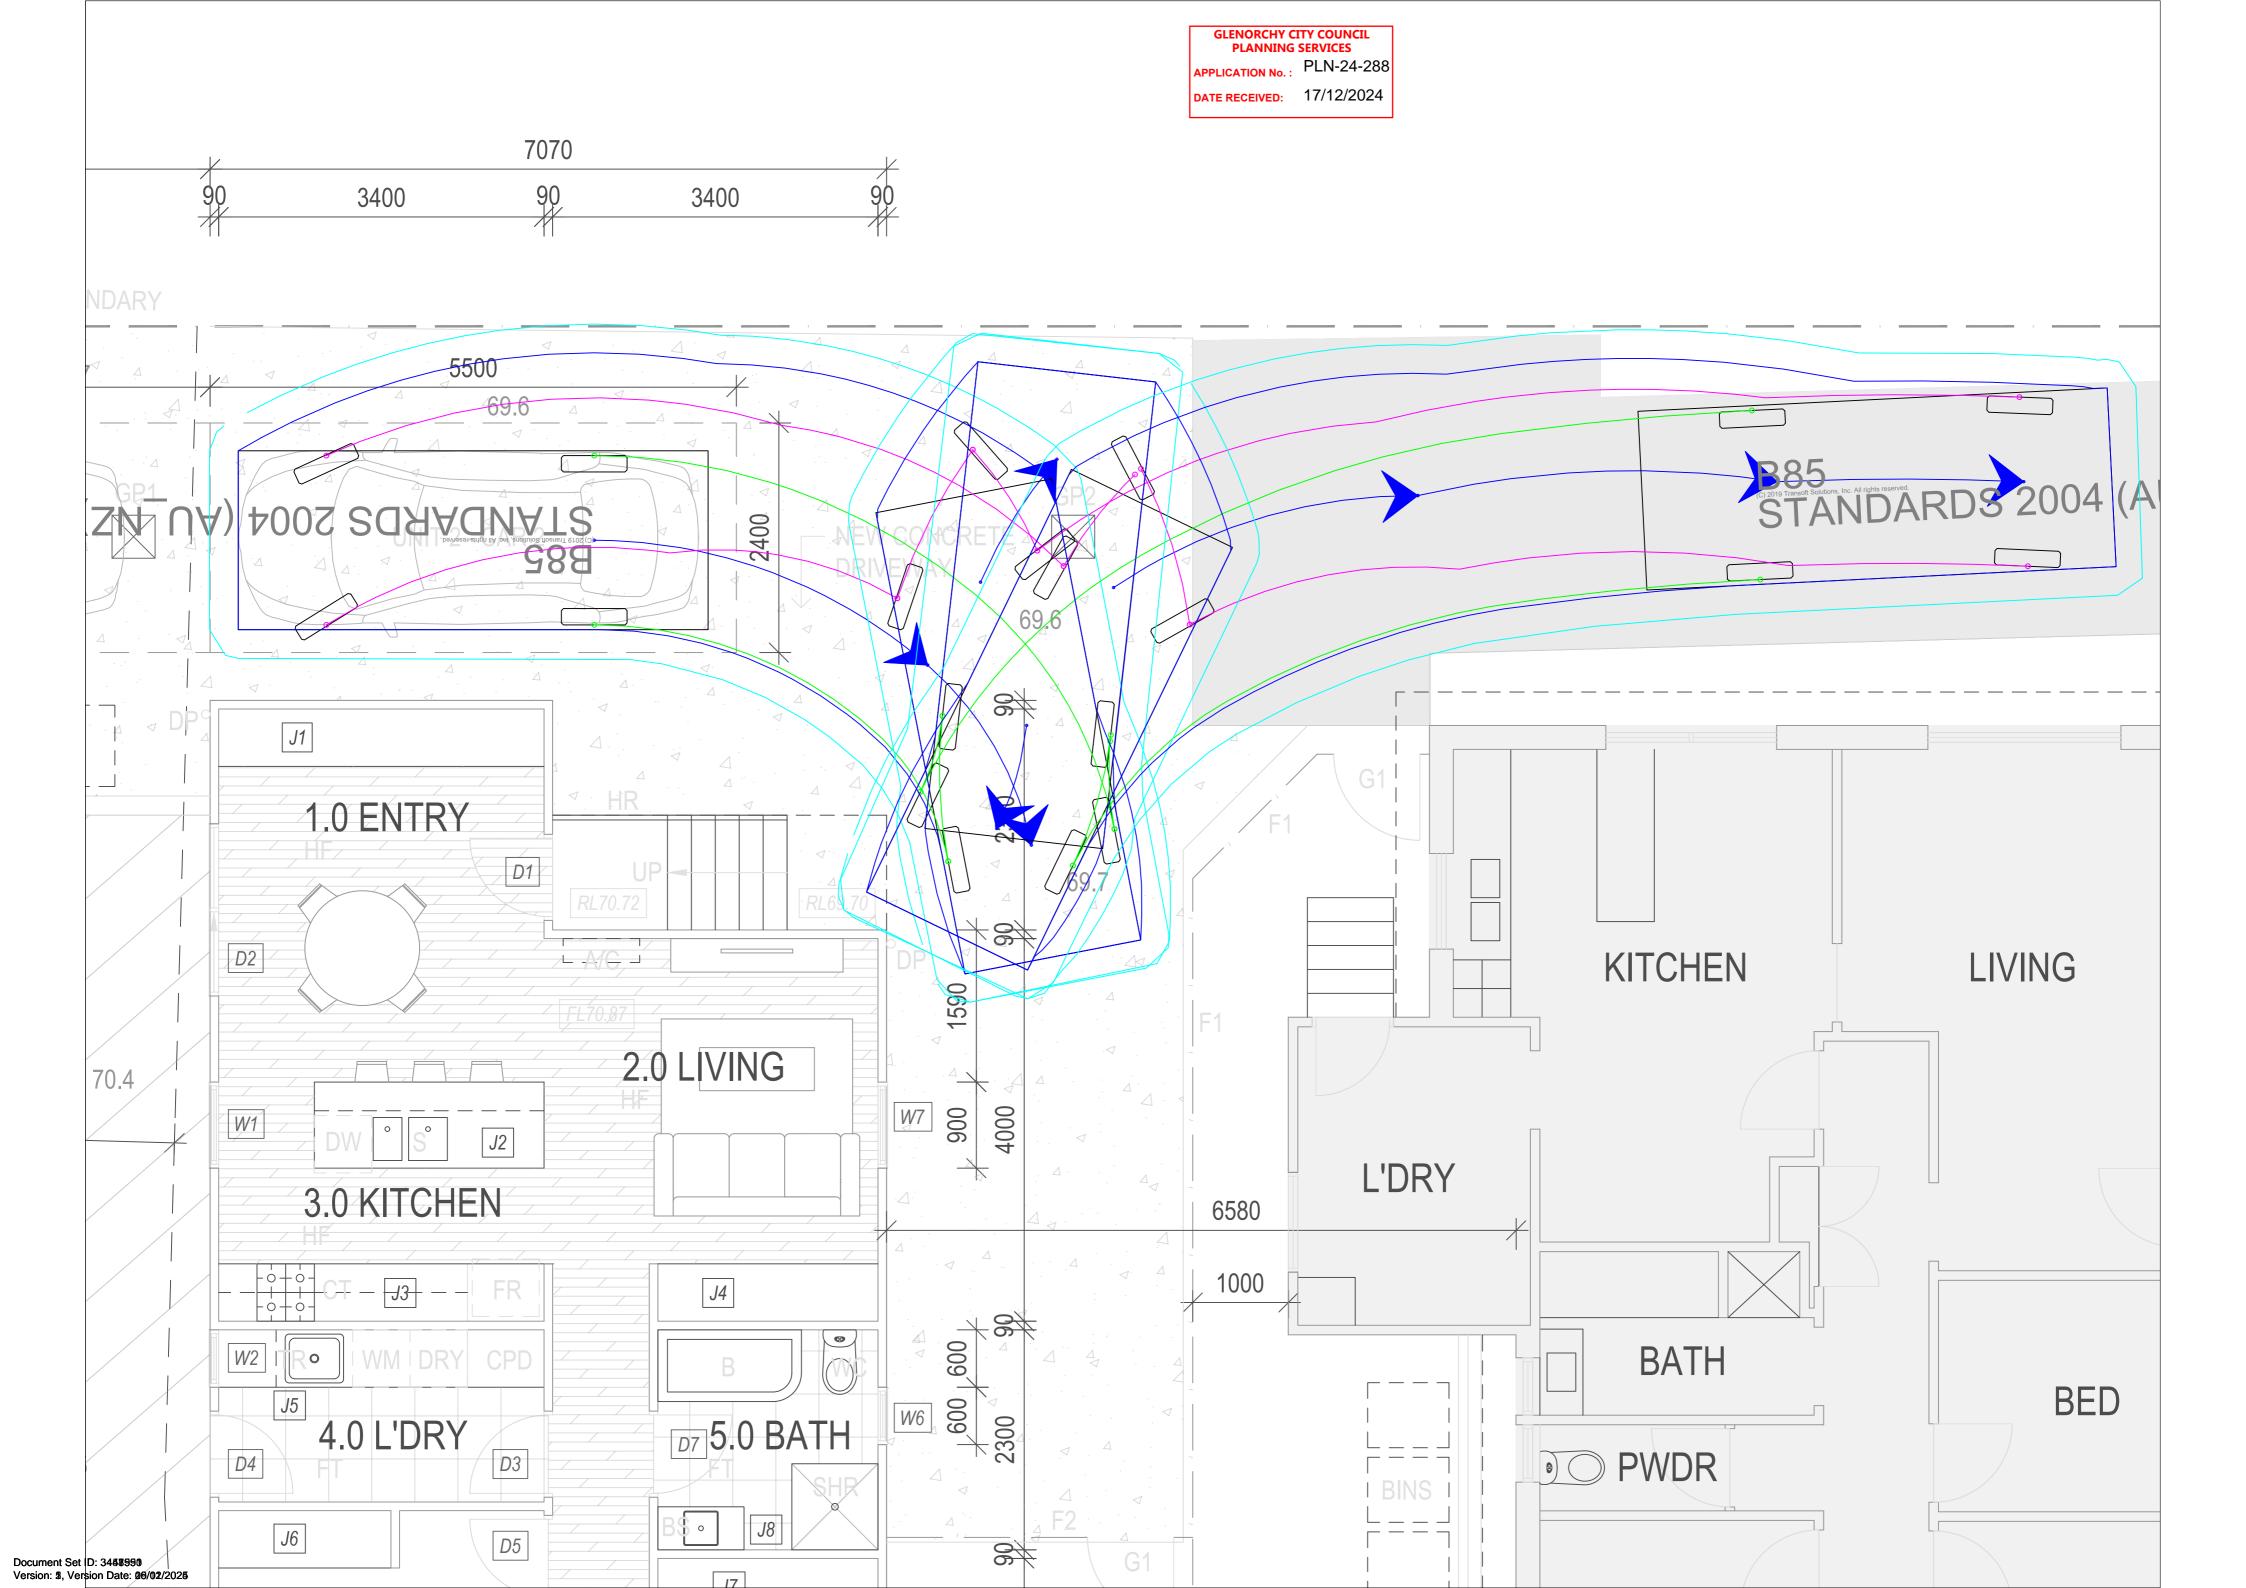


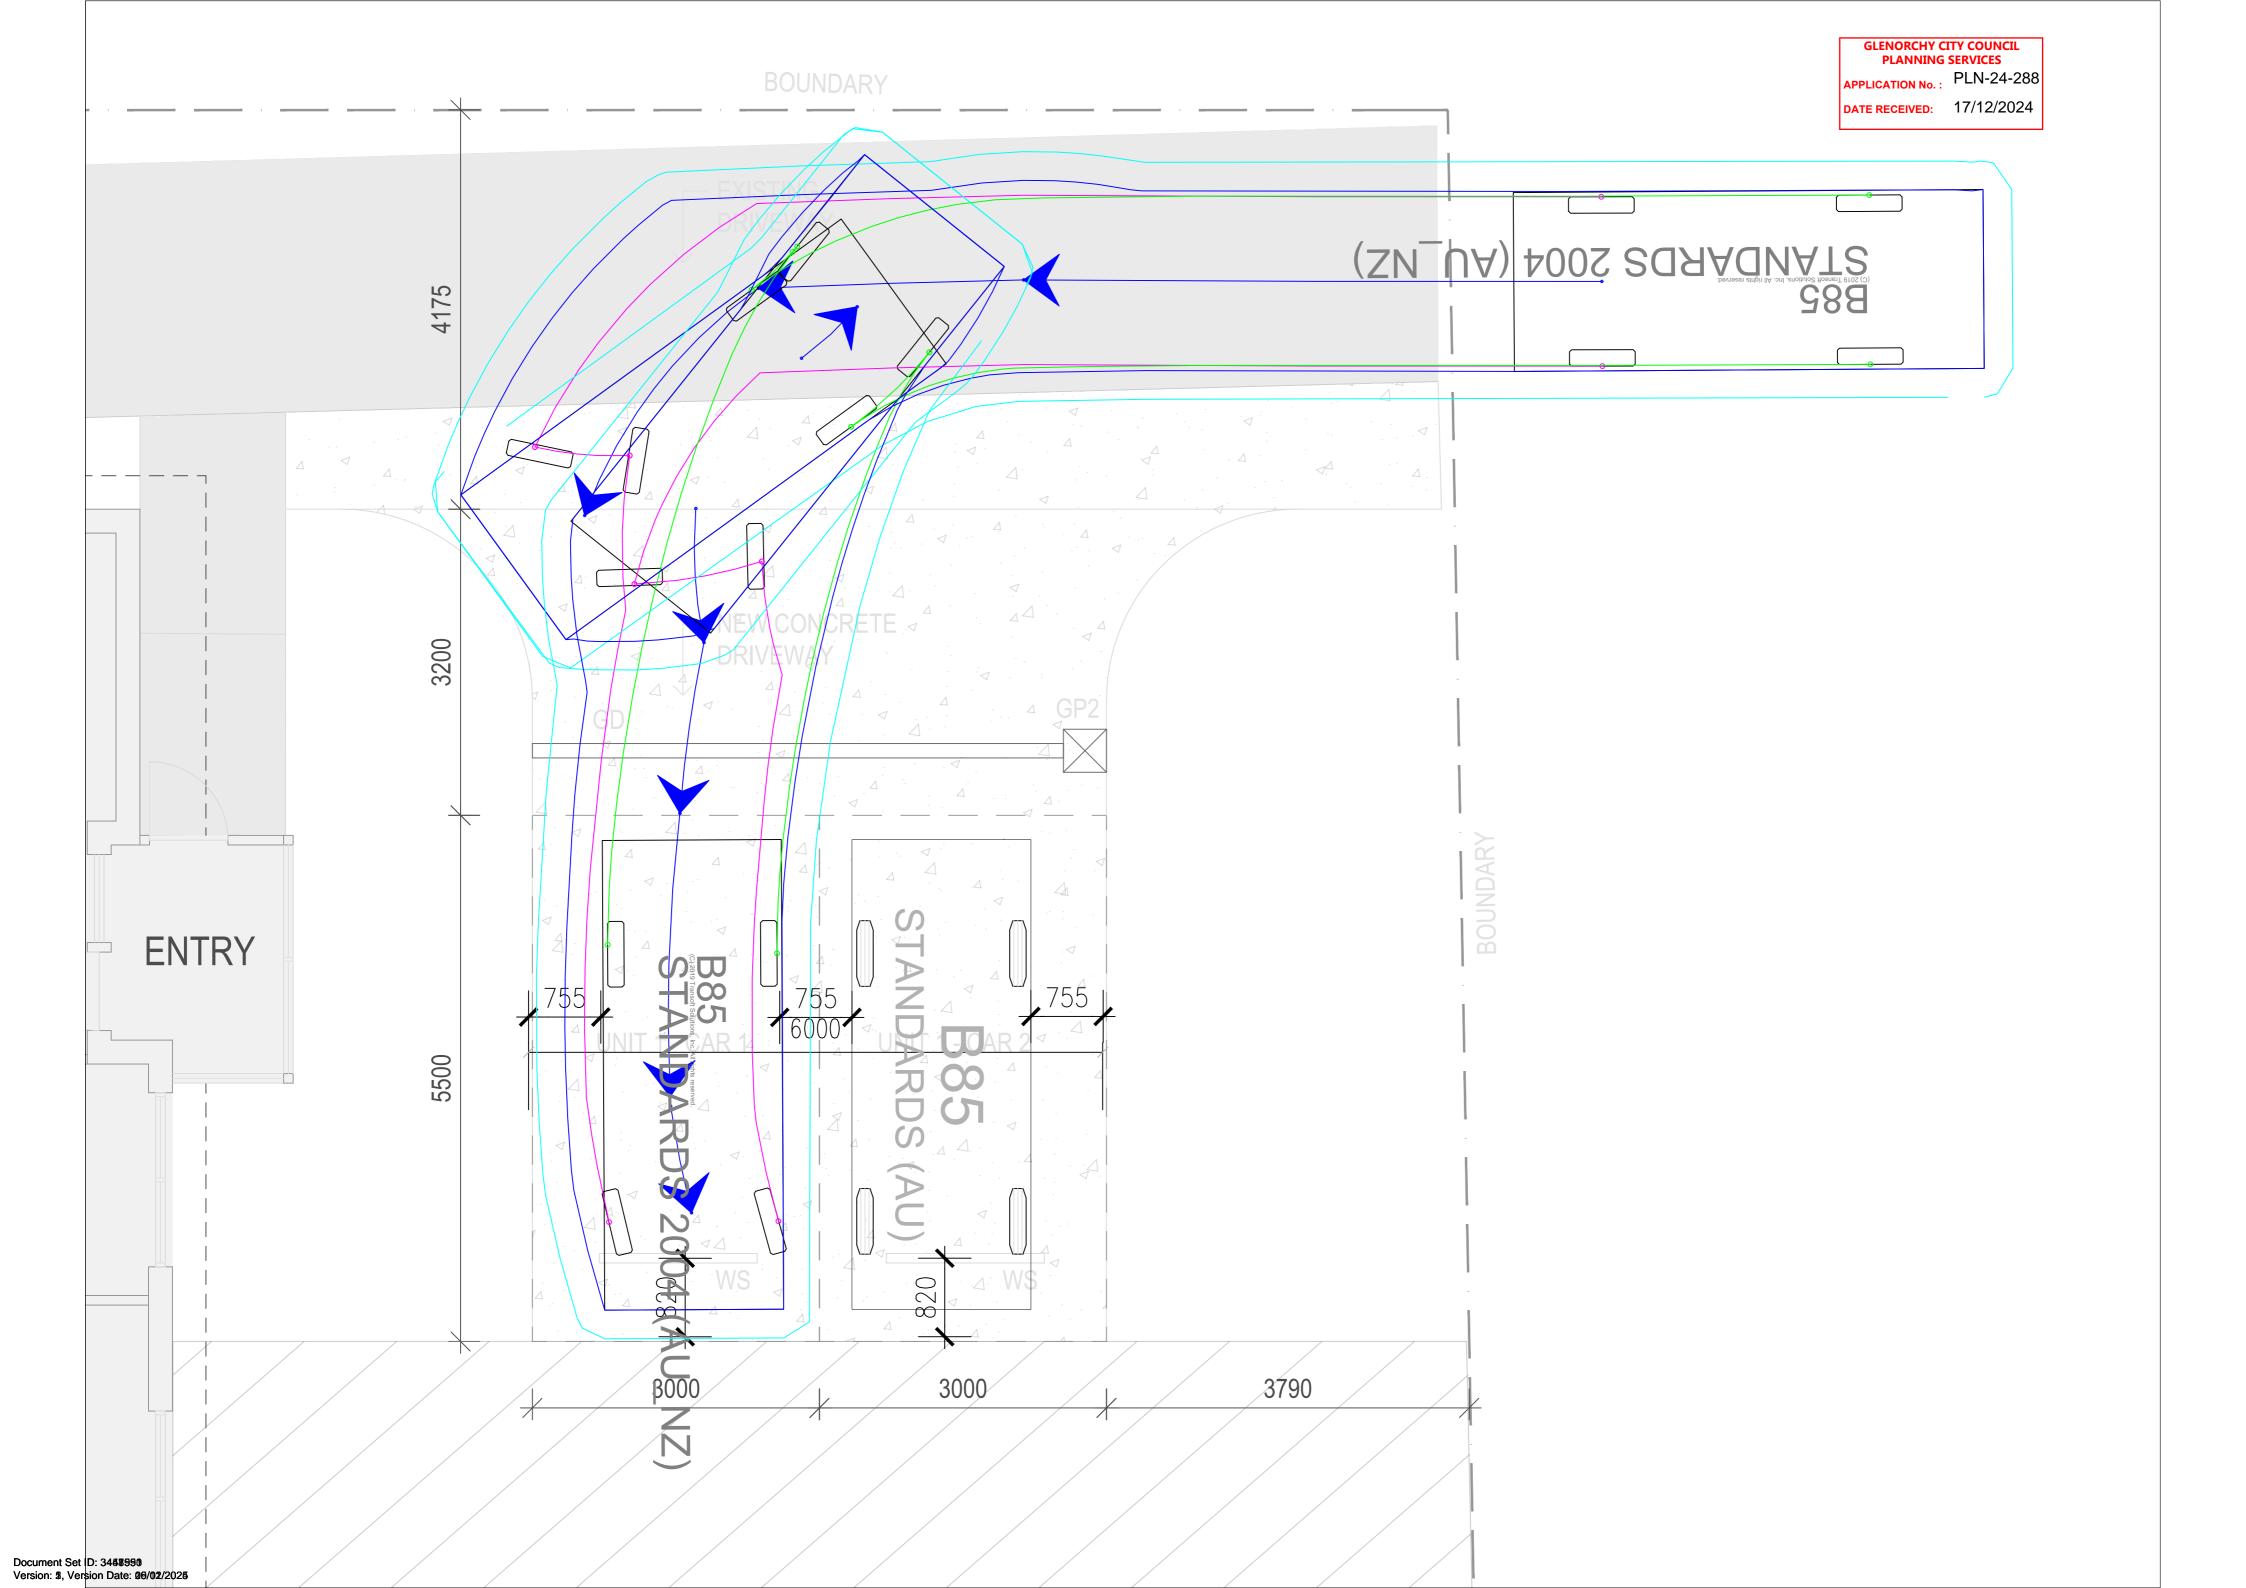

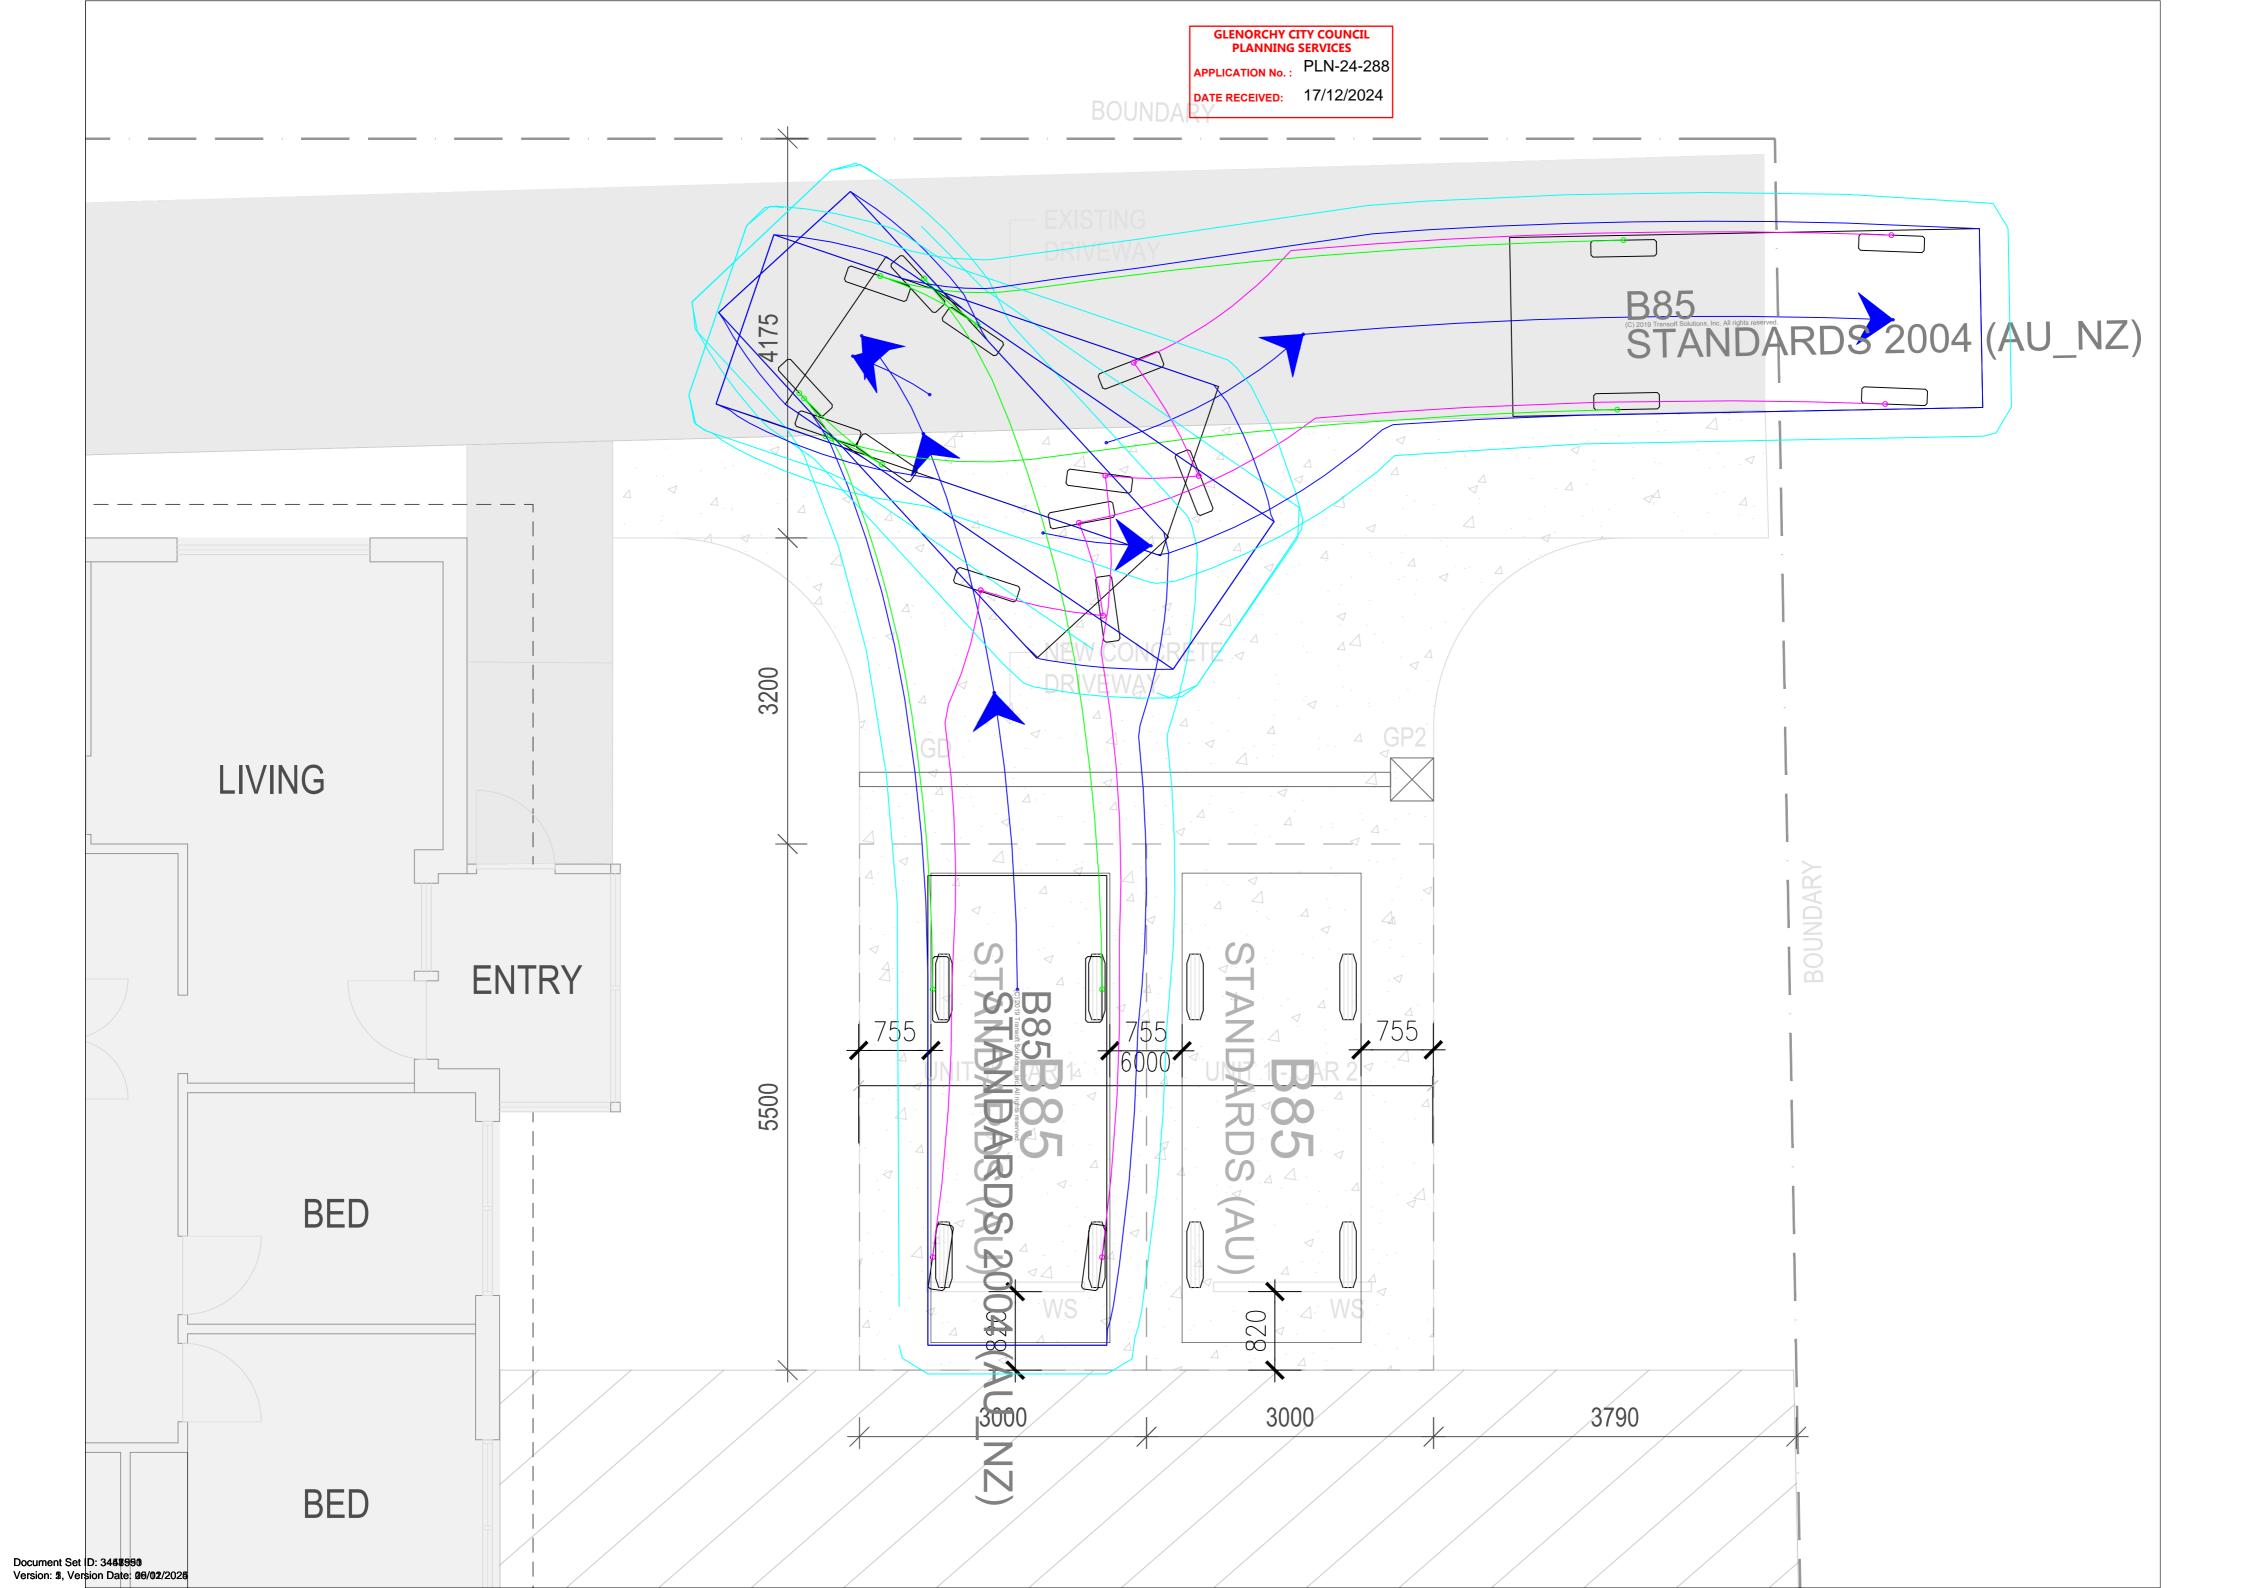

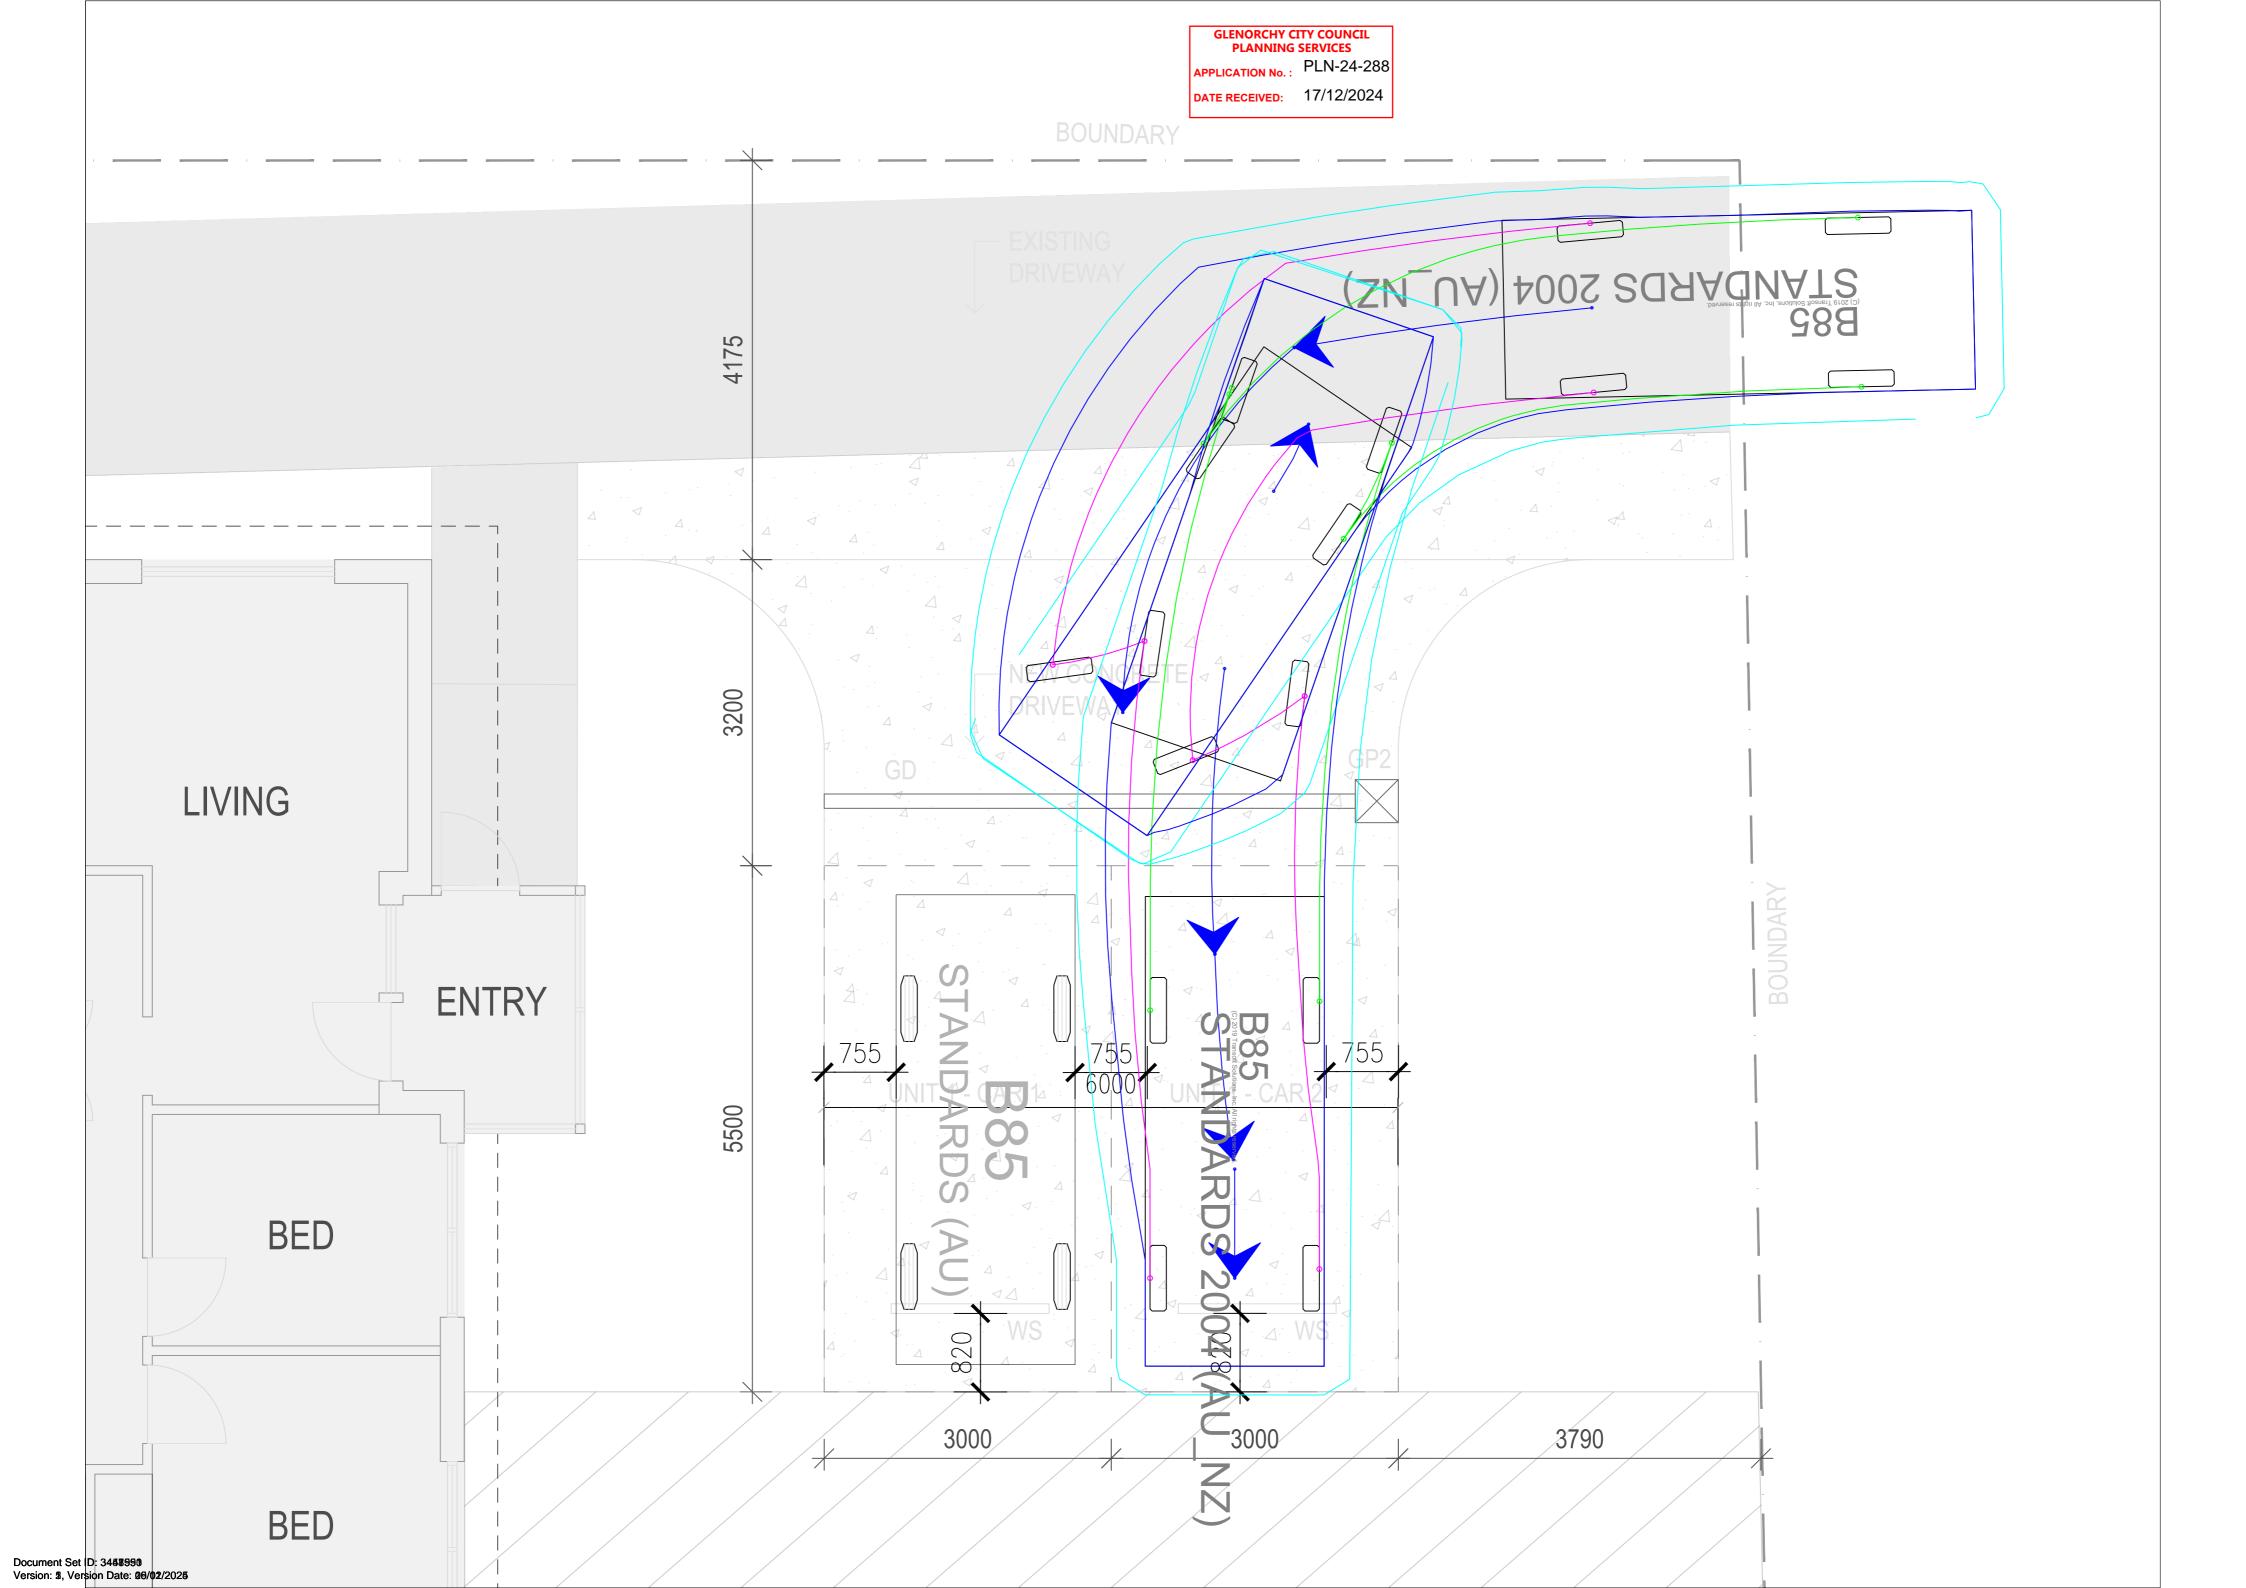

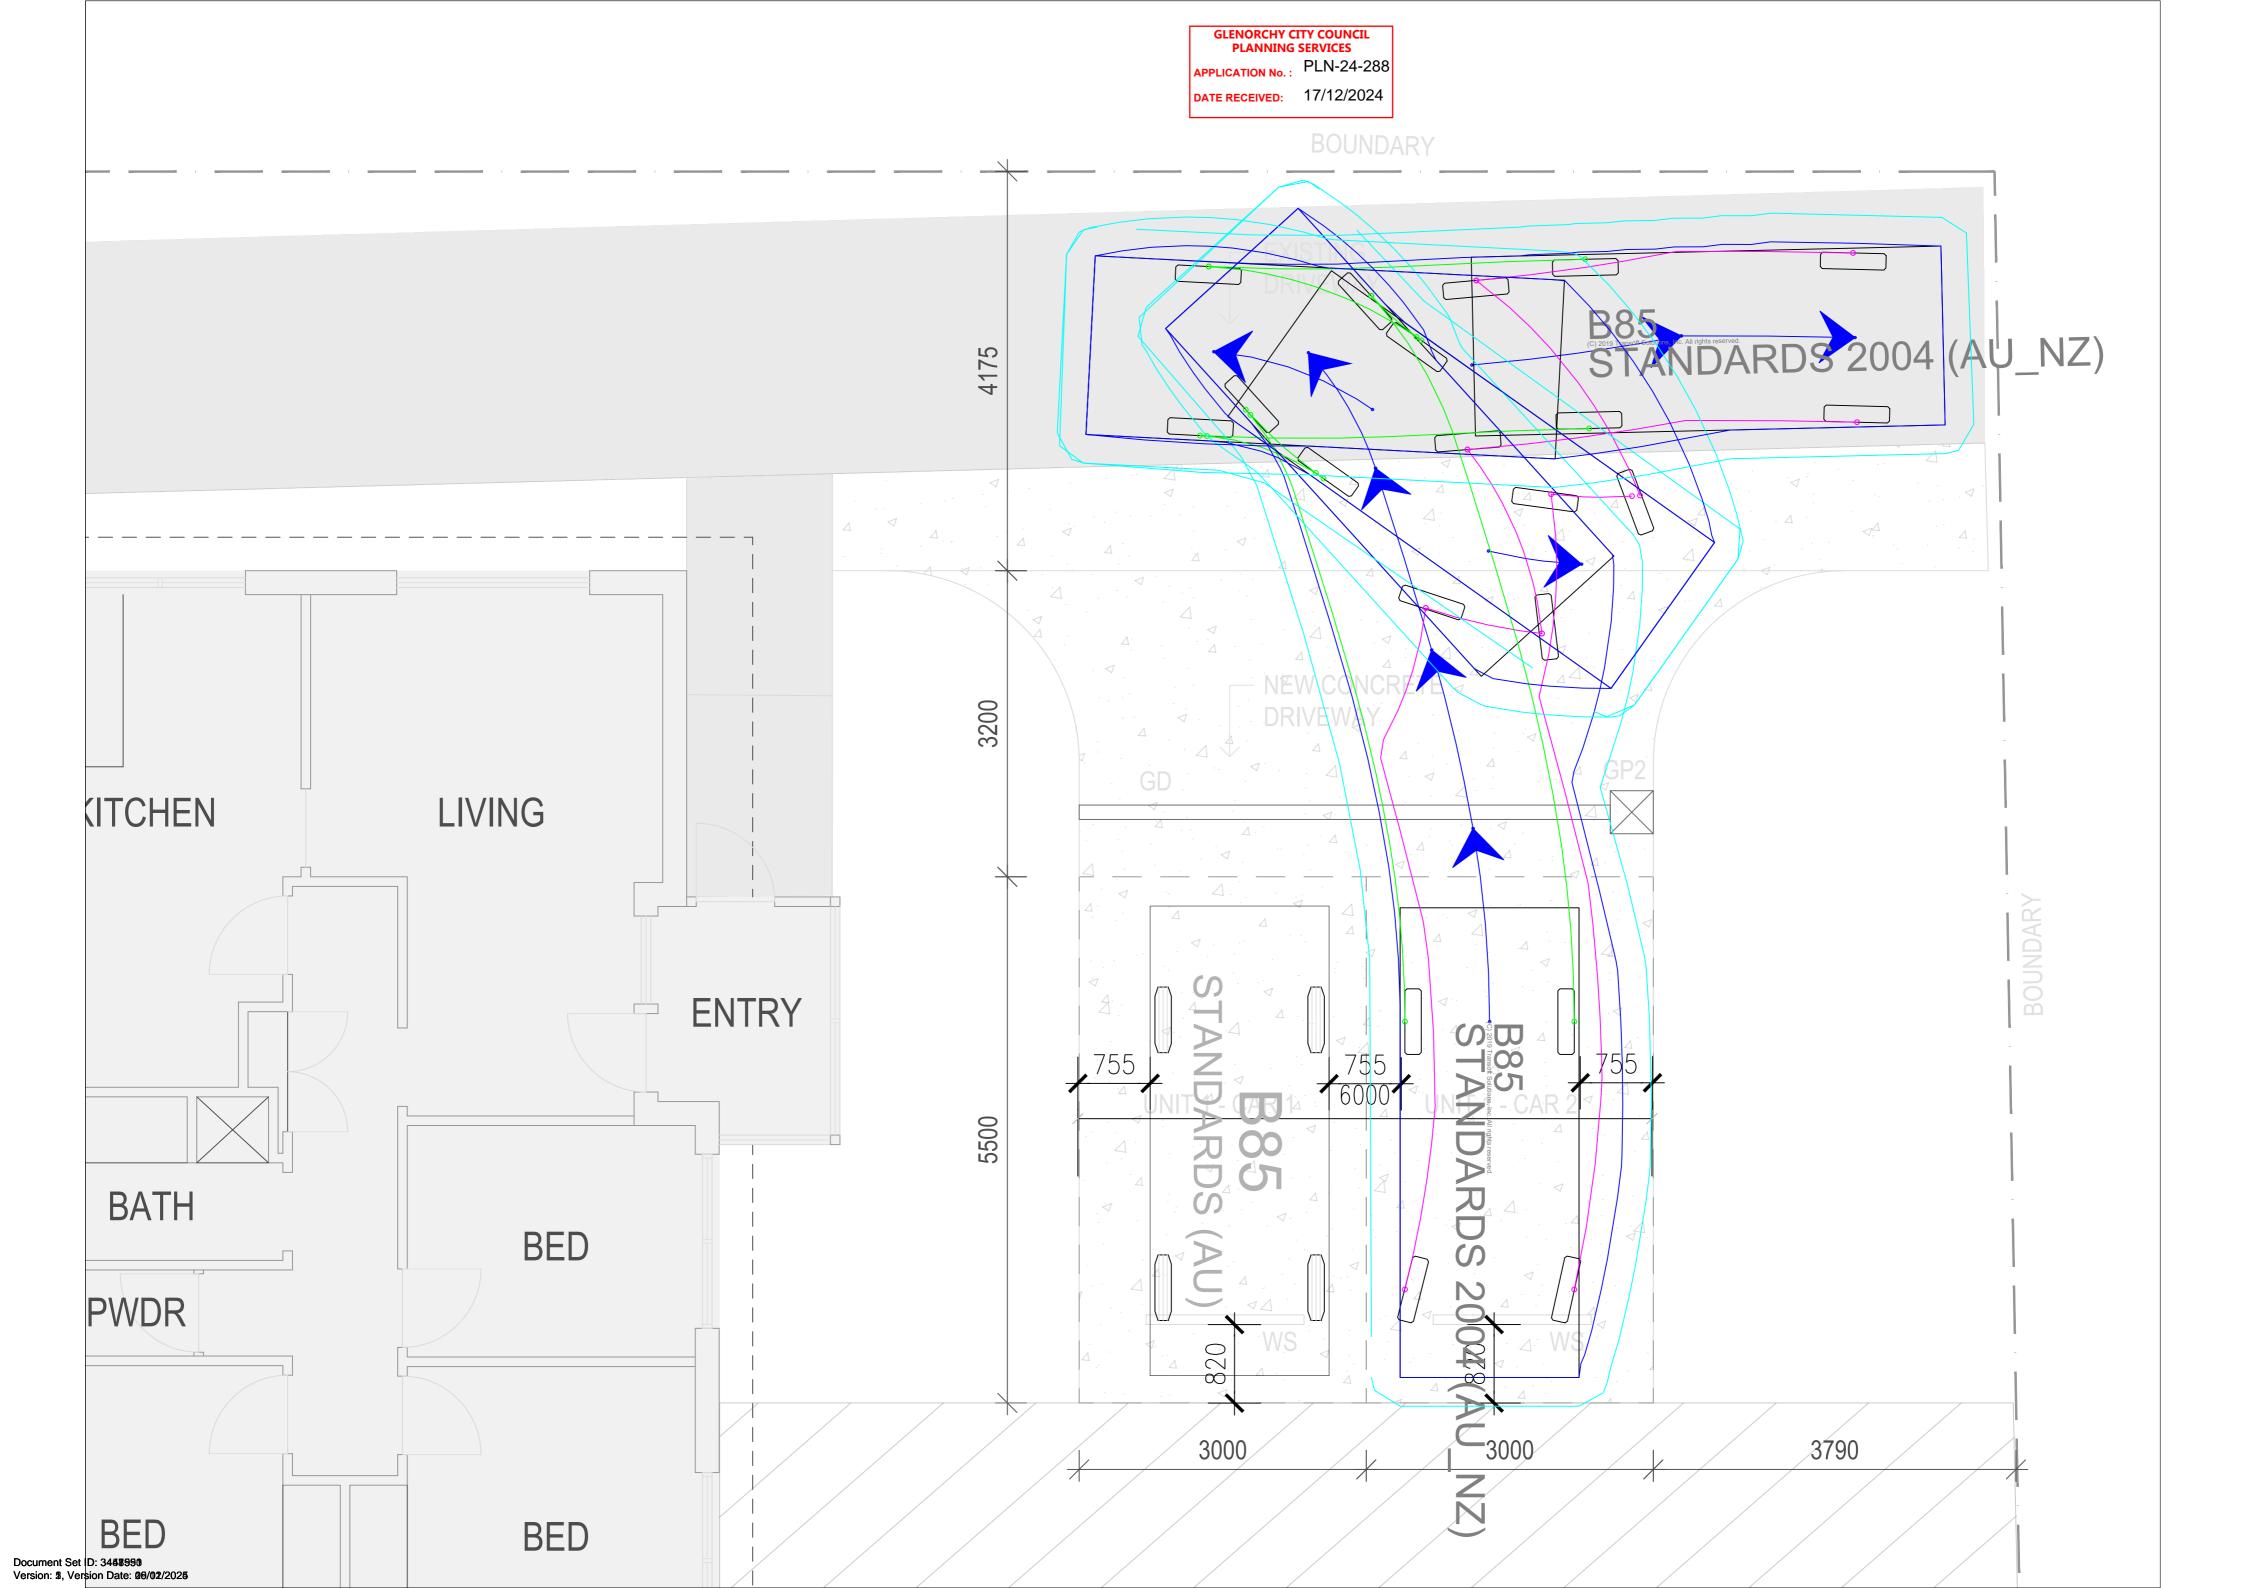

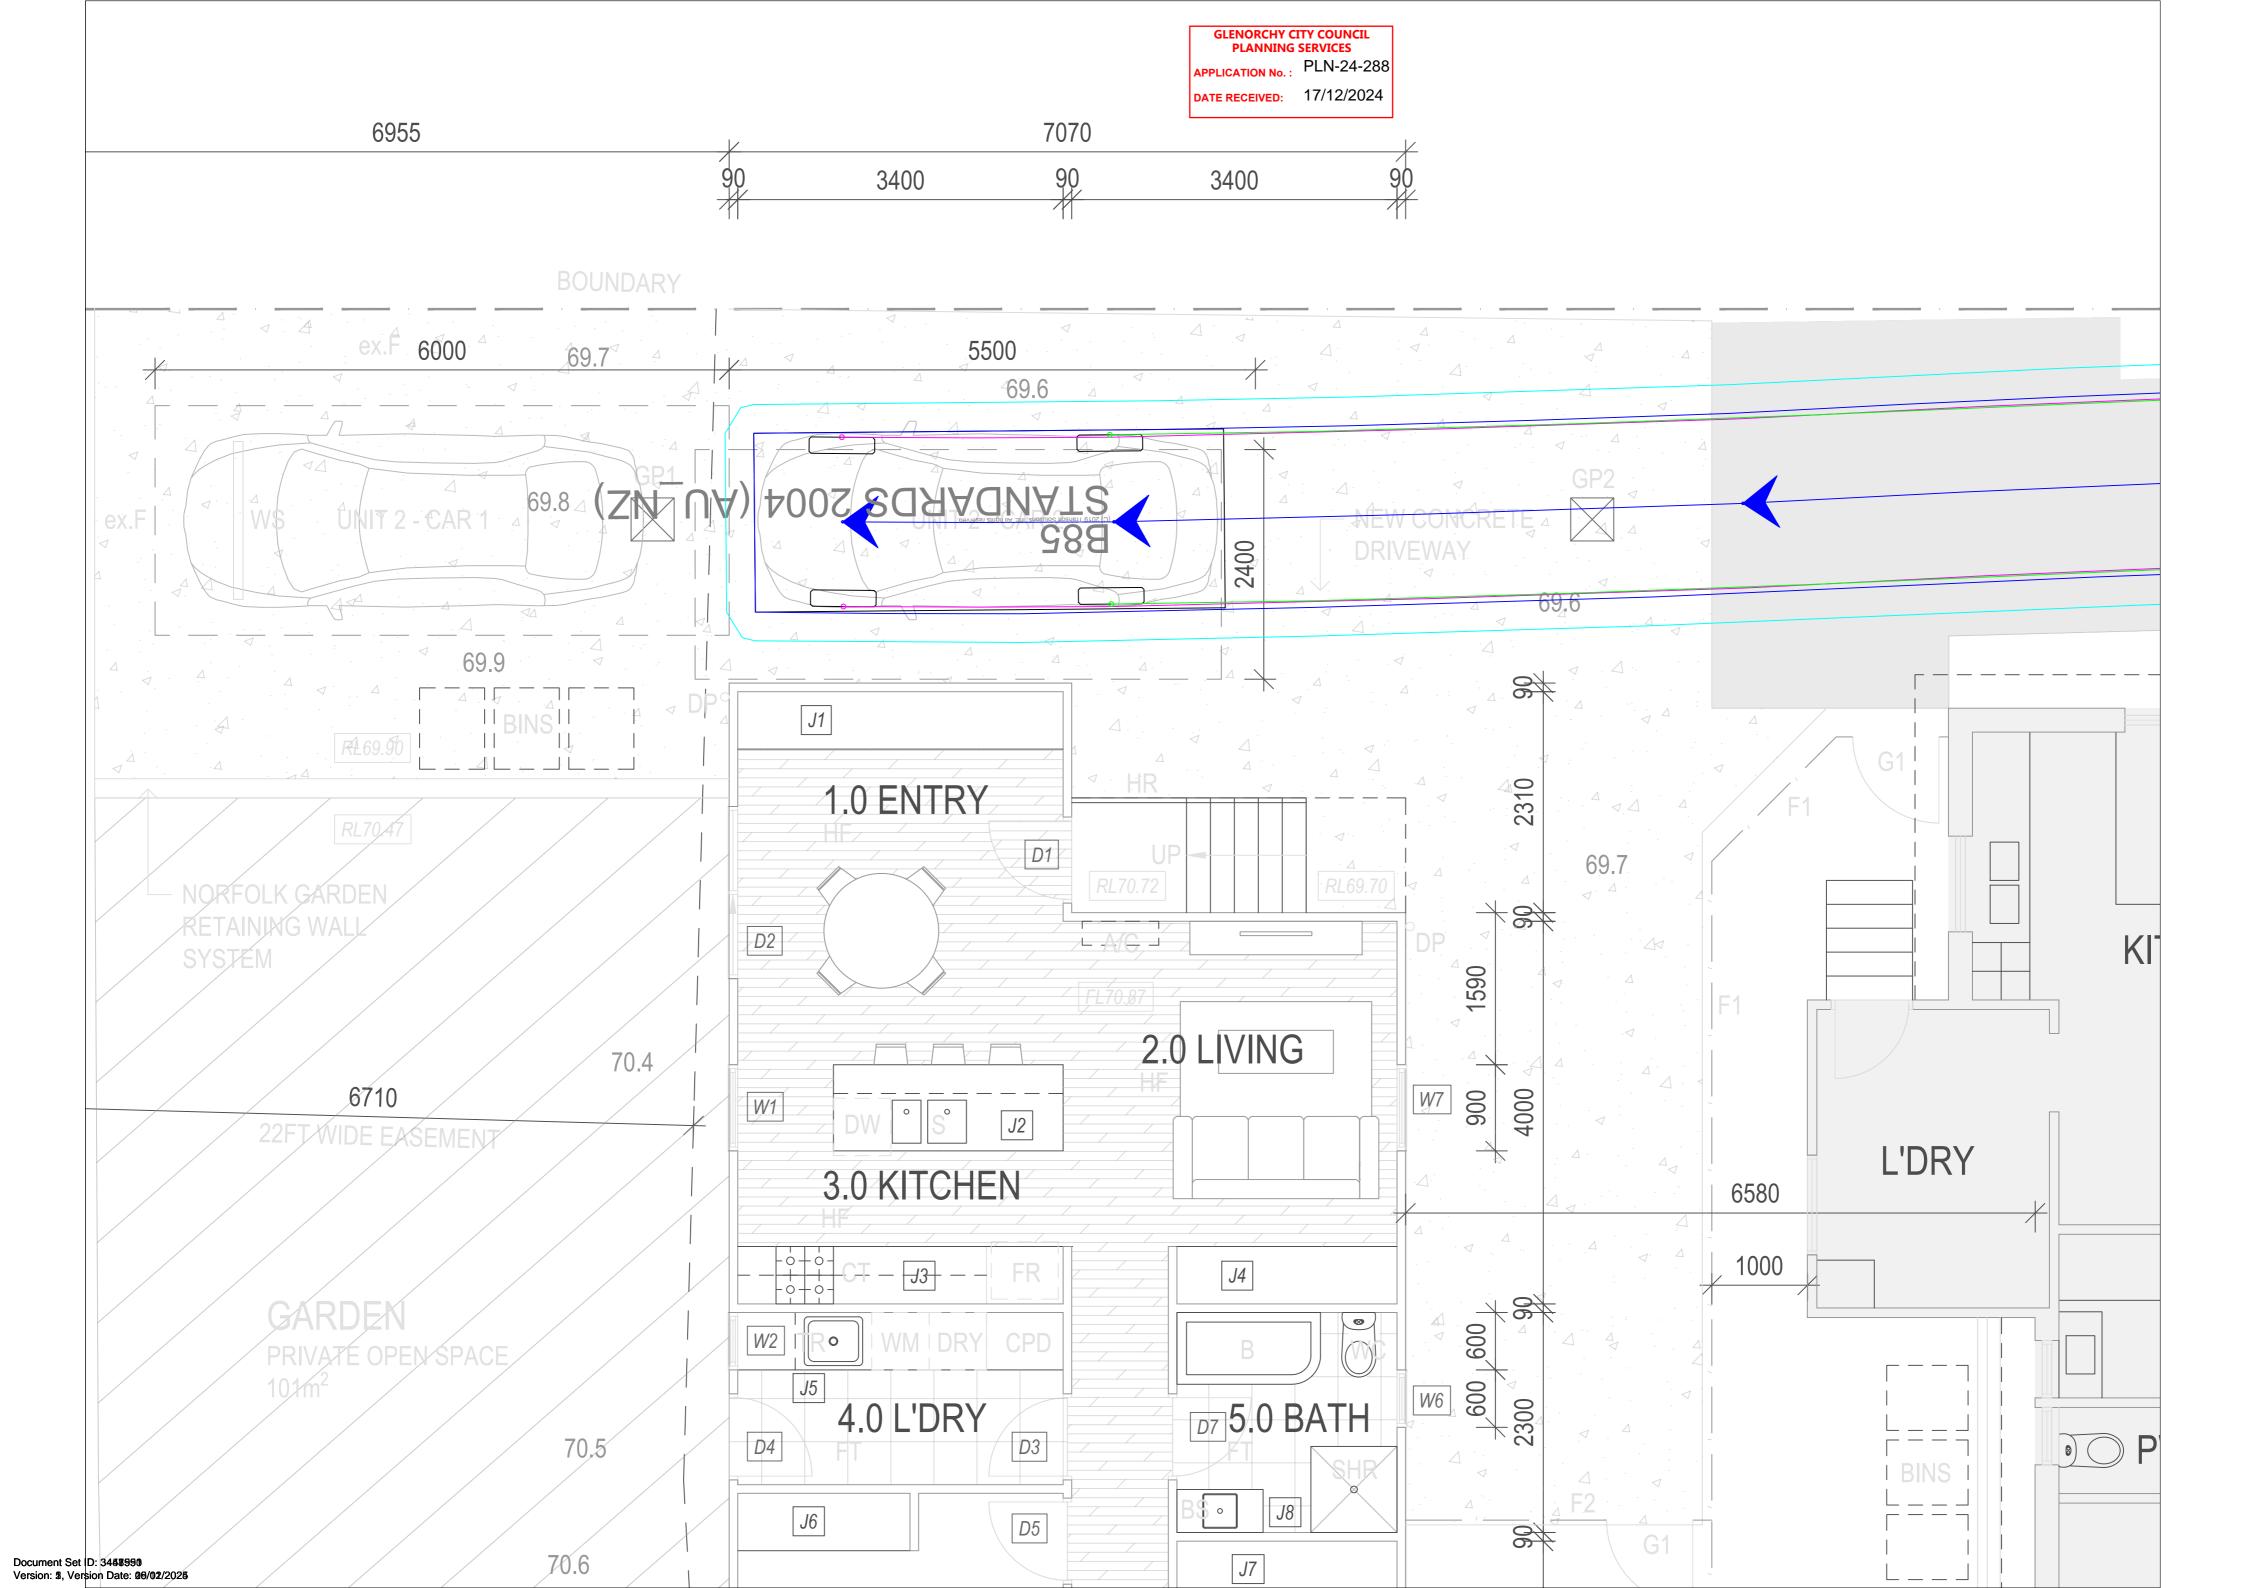

GLENORCHY CITY COUNCIL PLANNING SERVICES APPLICATION No.: PLN-24-288

DATE RECEIVED: 17/12/2024

HODX HOD CAPATED

PIT WITH INTEGRAL VED MIN DEEP SIT

FERENTION

EXISTING SINGLE STOREY DWELLING

(UNIT 1)

180 TANK

DUERHOW

RWP 22FT WIDE EASEMENT IBDSM

LAND: 352m²

HOUSE: 105m2

IDD DA UPVIC CHARGED SW

LINE TO TANK.

> 4000 LITRE BAIN WATER HARVEST TRNK TO COLLECT

RNP

BMS

DRG

1804W

WATER FROM REDFOFTHE PROPOSOD DWELLING.

100 OPTOW

NOT FOR CONSTRUCTION

NECOL

RWA

DRAINS FROM FOOTINGS TO


REC HYDRAULIC DESIGN CONSULTANTS CC963M

GLENORCHY CITY COUNCIL

PLANNING SERVICES

APPLICATION No.: PLN-24-288

DATE RECEIVED: 17/12/2024

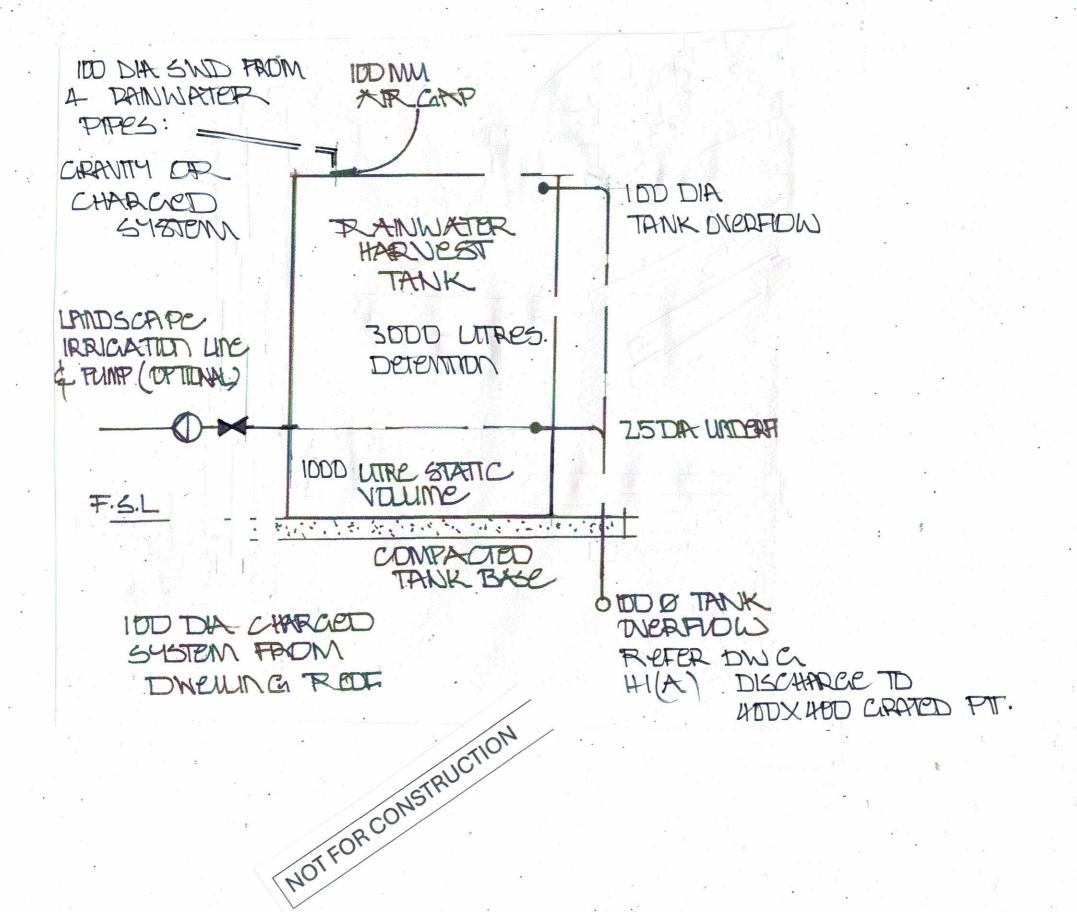

TEL - 0418 597 741 E - info@rechyd.com.au

DATE VASCALENB	DESIGNER: ROD COOPER	PROJECTO NADOLLO PL	CUARCINOTT
DRAWING No: DWG-H- 2	REV: A	TITLE CONCEPT	SERVICES

REC HYDRAULIC DESIGN CONSULTANTS CC963M

STORMWATER MANAGEMENT

SUPPLY AND INSTALL A RAINWATER TANK TO DETAIL DWG H2(A) - ALL ROOF WATER FROM THE NEW DWELLING WILL BE DIRECTED TO THE NEW HARVEST TANK AND OVERFLOW TO THE PRIVATE STORMWATER SYSTEM VIA A PIT. INSTALL COLLECTION PITS OF 400 X 400mm WITH INTEGRAL 200mm DEEP SILT RETENTION CHAMBERS BELOW THE INVERT OUTLET IN NOMINATED POSITIONS. AT DRIVEWAY THRESHOLDS INSTALL A GRATED TRENCH PLACED TO COLLECT ALL SURFACE RUN OFF FROM PAVED AREAS AND DISCHARGE TO THE STORMWATER CONECTION AS DETAILED.

GRATED PITS AND TRENCHES ARE TO BE FITTED WITH GALVANISED TRAFFICABLE REMOVABLE **GRATINGS**

RAINFALL FIGURES EXTRACTED FROM AS/NZS3500.3:2021 - TABLE D1

5% A.E.P % EVENT 120mm /HOUR

DWELLING ROOF AREA 150 SQ METRES

120 X 150 =18000 DIVIDE BY 3600 = 5 L/S X 300 (5 MINS) = 1500 LITRES VOLUME.

PROVIDE 1 X 4000 LITRE RAINWATER HARVEST TANK AS DETAILED TO PROVIDE 3000 LITRES OF VOID SPACE OR 2 RAINFALL EVENTS OF 1:20 YEAR INTENSITY PRIOR TO DISCHARGE TO THE DRAINAGE SYSTEM. (REFER TO DETAIL DWG H2(A)

CLIMATE CHANGE IS AN UNKNOWN FACTOR AND IS THEREFORE UNQUANTIFIABLE-THIS DESIGN IS PREPARED BASED ON STANDARDS AND CODES RELEVANT AND CURRENT AT THE DATE OF THE DESIGN. REC HYDRAULIC P/L DESIGN DO NOT ACCEPT ANY RESPONSIBILITY FOR THE FUTURE EFFECT OF DROUGHT, UNSEASONAL RAINFALL EVENTS, LACK OF SYSTEM MAINTENANCE OR OTHER OCCURRENCES RESULTING FROM THE EFFECTS OF FUTURE CLIMATE CHANGE. DATE DECEMBER 2024. ONGOING RESPONSIBILITY FOR MAINTENANCE OF THE SYSTEM REMAINS WITH THE PROPERTY OWNER.

PRIVATE SEWER

THE EXISTING DWELLING IS CURRENTLY CONNECTED TO THE TASWATER SEWER SYSTEM, THIS BRANCH IS TO BE MAINTAINED WITH AN UPGRADE AT THE BOUNDARY BRANCH CONNECTION TO MEET THE CURRENT STANDARD (REFER NOTE DWG H1(A) THE PRIVATE SEWER IS TO BE RELAID TO ENSURE THAT THE PROPOSED DWELLING IS CONNECTED SEPARATELY TO THE DRAIN. EACH BUILDING IS REQUIRED TO BE FITTED WITH AN OVERFLOW RELIEF GULLY FITTING AND A SEPARATE UPSTREAM VENT. ANY REMEDIAL WORK TO THE SEWER BRANCH WILL BE DONE BY TASWATER AT THE DEVELOPERS COST.

REC HYDRAULIC DESIGN CONSULTANTS CC963M

WATER SUPPLY

USING THE EXISTING WATER CONNECTION TAPPING TO THE TASWATER MAIN UPGRADE THE CONNECTION TO 20mm ID AND INSTALL 2 NEW 20mm ID SUBMETERS WITHIN THE PROPERTY BOUNDARY - ALL WORK ASSOCIATED WITH THE UPGRADE IS TO BE BY TASWATER AT THE DEVELOPERS COST.

> GLENORCHY CITY COUNCIL PLANNING SERVICES

PLN-24-288

DATE RECEIVED: 17/12/2024



Submission to Planning Authority Notice

Application details

Council Planning Permit No. PLN-24-288

Council notice date 21/10/2024

TasWater Reference No. TWDA 2024/01239-GCC

Date of response 23/10/2024

TasWater Contact Huong Pham

Phone No. 0427 471 748

Response issued to

Council name GLENORCHY CITY COUNCIL

Contact details gccmail@gcc.tas.gov.au

Development details

Address 2 NARELLE PL, CLAREMONT

Property ID (PID) 5337497

Description of development Multiple Dwellings x 2 (1 new + 1 ex) & Demolish Ex Building

Schedule of drawings/documents

Prepared by	Drawing/document No.	Revision No.	Issue date
James Ho Architecture	JHA_007_24 sheets DA01 & DA03	N/A	9/2024

Conditions

Pursuant to the *Water and Sewerage Industry Act* 2008 (TAS) Section 56P(1) TasWater imposes the following conditions on the permit for this application:

CONNECTIONS, METERING & BACKFLOW

 A suitably sized water supply with metered connection and sewerage system and connection to each lot of the development must be designed and constructed to TasWater's satisfaction and be in accordance with any other conditions in this permit.

Advice: If the sewer connection point is located in the driveway/parking area, trafficable cover will be required.

2. Any removal/supply and installation of water meters and/or the removal of redundant and/or installation of new and modified property service connections must be carried out by TasWater at the developer's cost.

Tasmanian Water & Sewerage Corporation Pty Ltd GPO Box 1393 Hobart, TAS 7001 development@taswater.com,.au ABN: 47 162 220 653

Page 1 of 3



3. Prior to commencing of the development, any water connection utilised for construction/the development must have a backflow prevention device and water meter installed, to the satisfaction of TasWater.

DEVELOPER CHARGES

- 4. Prior to TasWater issuing a Certificate(s) for Certifiable Work (Building) and/or (Plumbing), the applicant or landowner as the case may be, must pay a developer charge totalling \$1.054.20 to TasWater for water infrastructure for 0.60 additional Equivalent Tenements, indexed by the Consumer Price Index All groups (Hobart) from the date of this Submission to Planning Authority Notice until the date it is paid to TasWater.
- 5. Prior to TasWater issuing a Certificate(s) for Certifiable Work (Building) and/or (Plumbing), the applicant or landowner as the case may be, must pay a developer charge totalling \$1,317.75 to TasWater for sewerage infrastructure for 0.75 additional Equivalent Tenements, indexed by the Consumer Price Index All groups (Hobart) from the date of this Submission to Planning Authority Notice until the date it is paid to TasWater.

DEVELOPMENT ASSESSMENT FEES

6. The applicant or landowner as the case may be, must pay a development assessment fee of \$242.85 to TasWater, as approved by the Economic Regulator and the fee will be indexed, until the date paid to TasWater.

The payment is required within 30 days of the issue of an invoice by TasWater.

Advice

General

For information on TasWater development standards, please visit https://www.taswater.com.au/building-and-development/technical-standards
For application forms please visit https://www.taswater.com.au/building-and-development/development-application-form

Developer Charges

For information on Developer Charges please visit the following webpage – https://www.taswater.com.au/building-and-development/developer-charges

Water Submetering

As of July 1 2022, TasWater's Sub-Metering Policy no longer permits TasWater sub-meters to be installed for new developments. Please ensure plans submitted with the application for Certificate(s) for Certifiable Work (Building and/or Plumbing) reflect this. For clarity, TasWater does not object to private sub-metering arrangements. Further information is available on our website (www.taswater.com.au) within our Sub-Metering Policy and Water Metering Guidelines.

Service Locations

Please note that the developer is responsible for arranging to locate the existing TasWater infrastructure and clearly showing it on the drawings. Existing TasWater infrastructure may be located by a surveyor and/or a private contractor engaged at the developers cost to locate the infrastructure.

Page 2 of 3



- (a) A permit is required to work within TasWater's easements or in the vicinity of its infrastructure. Further information can be obtained from TasWater.
- (b) TasWater has listed a number of service providers who can provide asset detection and location services should you require it. Visit https://www.taswater.com.au/building-and-development/service-locations for a list of companies.
- (c) Sewer drainage plans or Inspection Openings (IO) for residential properties are available from your local council.

NOTE: In accordance with the WATER AND SEWERAGE INDUSTRY ACT 2008 - SECT 56ZB A regulated entity may charge a person for the reasonable cost of -

- (a) a meter; and
- (b) installing a meter.

Declaration

The drawings/documents and conditions stated above constitute TasWater's Submission to Planning Authority Notice.